



Regional District of Okanagan-Similkameen

Construction Services for the Oliver Landfill Organics Composting Facility

To: Posted on BC Bid Website From: Scott Garthwaite, AScT

ITT: RDOS-22-ENG-05 **Date:** April 28, 2022

Attachments: Addendum #1 Pages: 2

Please take note that RDOS has issued the attached Addendum #1 to address the questions and answers for the Invitation to Tender RDOS-22-ENG-05.

This Addendum forms part of the contract documents and is to be read, interpreted, co-ordinated with all other parts. The cost of all contained herein is to be included in the contract sum. The following revisions supersede the information contained in the original drawings and specifications issued for the above-named project to the extent referenced and become part thereof.

This Addendum includes the following information:

- A. Questions and Answers
- B. Appendix A Revised Civil Drawings from Sperling Hansen 000 Series (reflecting revisions from Addendum #1)
- C. Appendix B Revised Instructions to Tenderers Part 1 (reflecting revisions from Addendum #1)
- D. Appendix C Revised Schedule A Supplementary General Conditions (reflecting revisions from Addendum #1)



A. Questions and Answers


- Q1: The "Deadmen" & "Hold Down Straps" indicated on drawing 250053-009 are usually designed by the engineer. Is there design specs for these items?
- A1: The "Deadman" & "Hold Down Straps" are to be designed by the Tank Supplier. Shop drawings will be reviewed and approved with the Proponent through the Submittal Process as referenced in the Contract Documents.
- Q2: The 8'x8' Seacan required for the electrical service Kiosk has no required specification or rather requirement of "Condition". Is a New Seacan the requirement, or a refurbished Seacan acceptable?
- A2: A refurbished Seacan is acceptable.



Appendix A

Revised Civil Drawings from Sperling Hansen 000-Series (reflecting revisions from Addendum #1)

OLIVER LANDFILL COMPOST FACILITY DESIGN

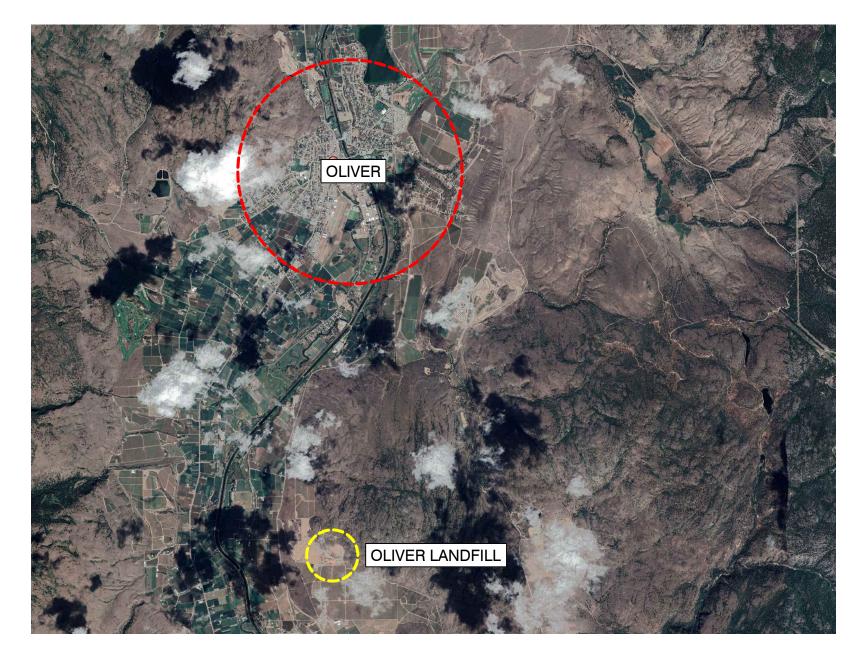

DRAWING LIST							
SHEET No.	DWG No.	REV.	TITLE				
	000 SERIES - EAI	RTHWORK A	AND LEACHATE MANAGEMENT				
000	20053-000	D	COVER PAGE, LEGEND AND DRAWING LIST				
001	20053-001	D	EXISTING TOPOGRAPHY 2020-10-20 EG + 2022-01-20 EG				
002	20053-002	D	COMPOST FACILITY DESIGN SUBGRADE				
003	20053-003	D	CUT/FILL DESIGN SUBGRADE VS 2020-10-20 EG + 2022-01-20 EG				
004	20053-004	D	COMPOST FACILITY SITE AND TRAFFIC LAYOUT				
005	20053-005	D	LEACHATE MANAGEMENT LAYOUT				
006	20053-006	D	COMPOSTING PAD, ACCESS ROAD DETAIL				
007	20053-007	D	GORE COMPOSTING DETAILS				
008	20053-008	D	COVERALL BUILDING DETAILS				
009	20053-009	D	SECTION A-A'				
010	20053-010	D	SECTION B-B'				
011	20053-011	D	SECTION C-C'				
012	20053-012	D	LEACHATE SYSTEM SCHEMATICS				
	100 SERIES -	ELECTRICA	L FOR COMPOST FACILITY				
100	20053-100	0	ELECTRICAL SITE PLAN				
101	20053-101	0	ELECTRICAL DETAILS				
103	20053-103	0	ELECTRICAL SCHEDULES AND SPECIFICATION				
	200 SERIES - W	ATER SUPF	PLY FOR COMPOST FACILITY				
200	20053-200	2	COVER PAGE				
201	20053-201	2	PLAN & PROFILE 0+000 TO 0+370				
202	20053-202	2	PLAN & PROFILE 0+370 TO 0+750				
203	20053-203	2	PLAN & PROFILE 0+750 TO 1+130				
204	20053-204	2	PLAN & PROFILE 1+130 TO 1+180 AND DETAILS				
205	20053-205	2	PRE-PACKAGED BOOSTER STATION KIOSK PLAN,SECTION AND DETAILS				
E01	E01	1	ELECTRICAL SITE PLAN				
E02	E02	1	BOOSTER STATION PLAN AND SECTION				



MAJOR EXISTING CONTOUR (5m) MINOR EXISTING CONTOUR (1m) MAJOR DESIGN CONTOUR (0.5m) - MINOR DESIGN CONTOUR (0.1m) SURFACE WATER DITCH

CLEAN WATER SUPPLY LINE - PRPOSED LEACHATE PIPE

— - - — PROPERTY LINE BOUNDARY ROAD DESIGN

EXISTING ROAD LEACHATE RE-CIRCULATION STAND

O CLEAN WATER STAND PIPE



Landfill Services Group Landfill Siting
 Design & Operations Plans
 Landfill Closure
 Environmental Monitoring Sperling HANSEN Associates

> #8 - 1225 Keith Road East North Vancouver, B.C. V7J 1J3 Phone: (604) 986-7723 Fax: (604) 986-7734

SEAL

							Г
]
]
]
]
]
]
]
D)	2022/03/14	ISSUE FOR TENDER	AT	MC/SG	MC]
С	;	2022/01/25	ISSUE FOR CLIENT REVIEW	AT	MC/SG	MC]
No	э.	DATE yr/m/day	REVISIONS	DRAWN	CHK'D	APP'D	


REUSE OF DOCUMENTS


This drawing is of a confidential nature and shall not be reproduced in any manner nor used for any purpose whatsoever except by written permission of Sperling


This drawing is not approved for construction unless it bears a signed and dated engineer's stamp, affixed on or after the date of the last revision.


REGIONAL DISTRICT
RDOS
OKANAGAN- SIMILKAMEEN


DESIGN BY:	МС	SHA PROJECT # 20053	OLIVER LANDFILL COMPOST FACILITY DESIGN		SIGN
			COM COTTAC		, and
DRAWN BY:	AT	DATE CREATED: 2022/03/14	COVER PAGE, LEGEND		D.
CHECKED BY:	MC/SG	HORIZONTAL SCALE: NTS	AND DRAWING LIST		
			DRAWING NO:	REV	SHEET
APPROVED BY:	MC	VERTICAL SCALE: NTS	22252 222	,	
ADJUST SCALE 50% FOR 34"x22" SHEET			20053-000	D	000

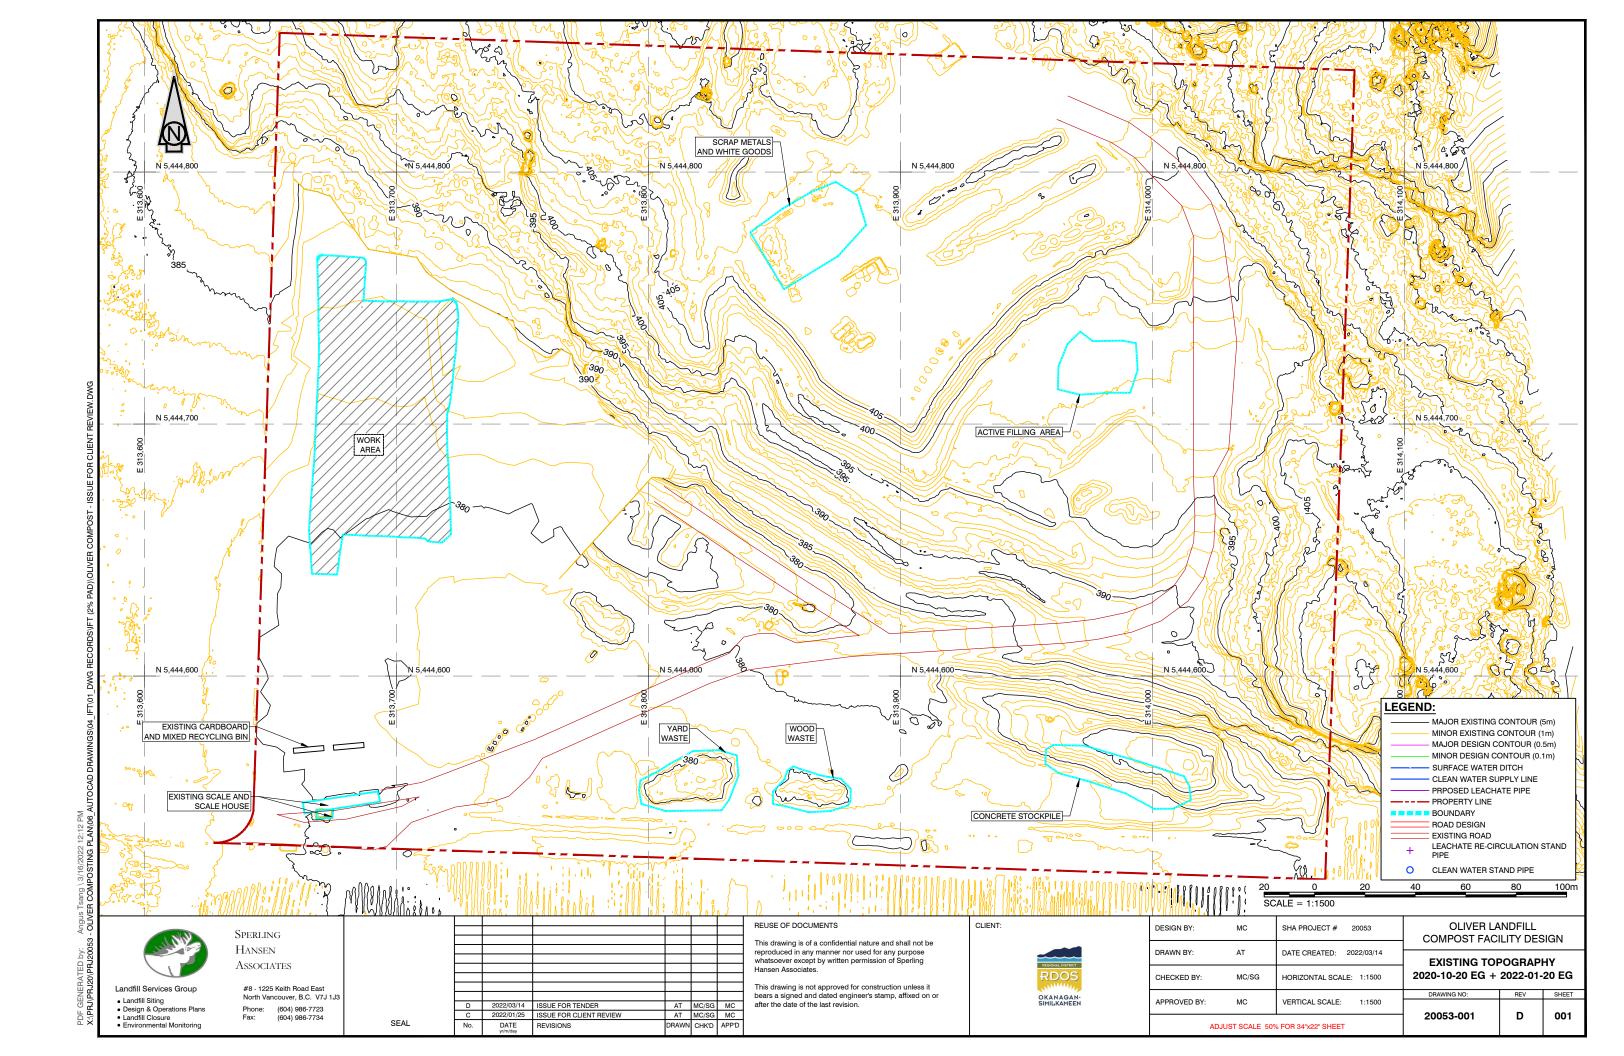


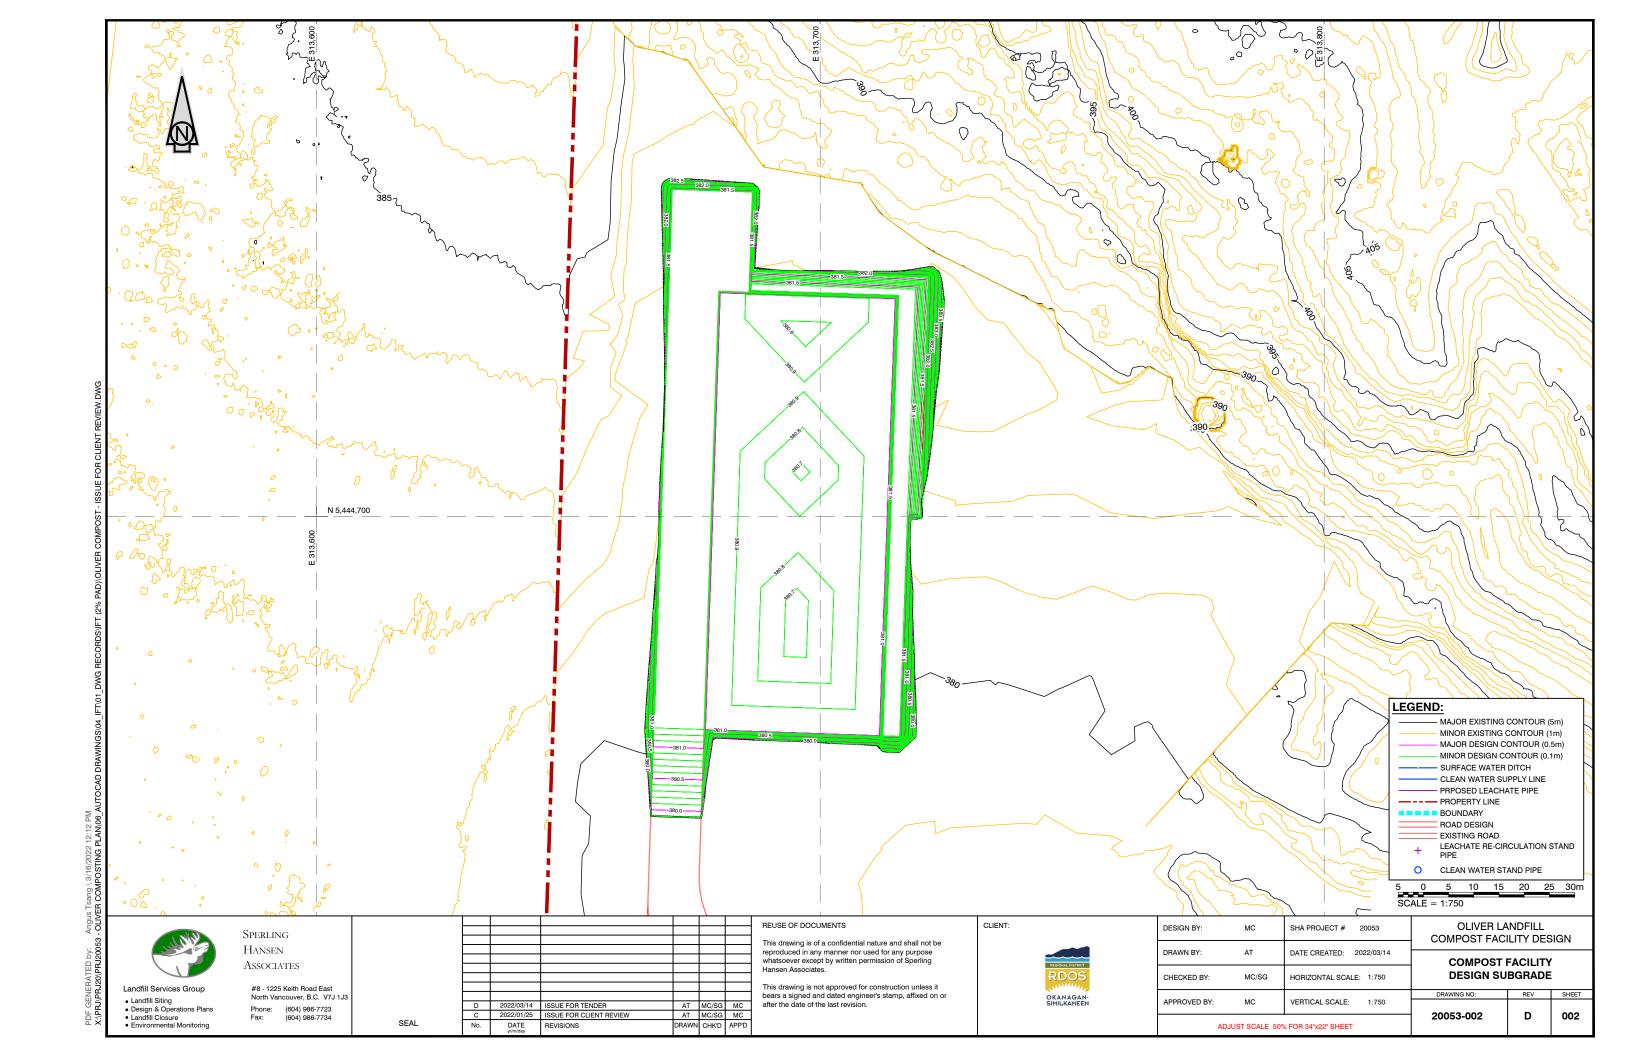

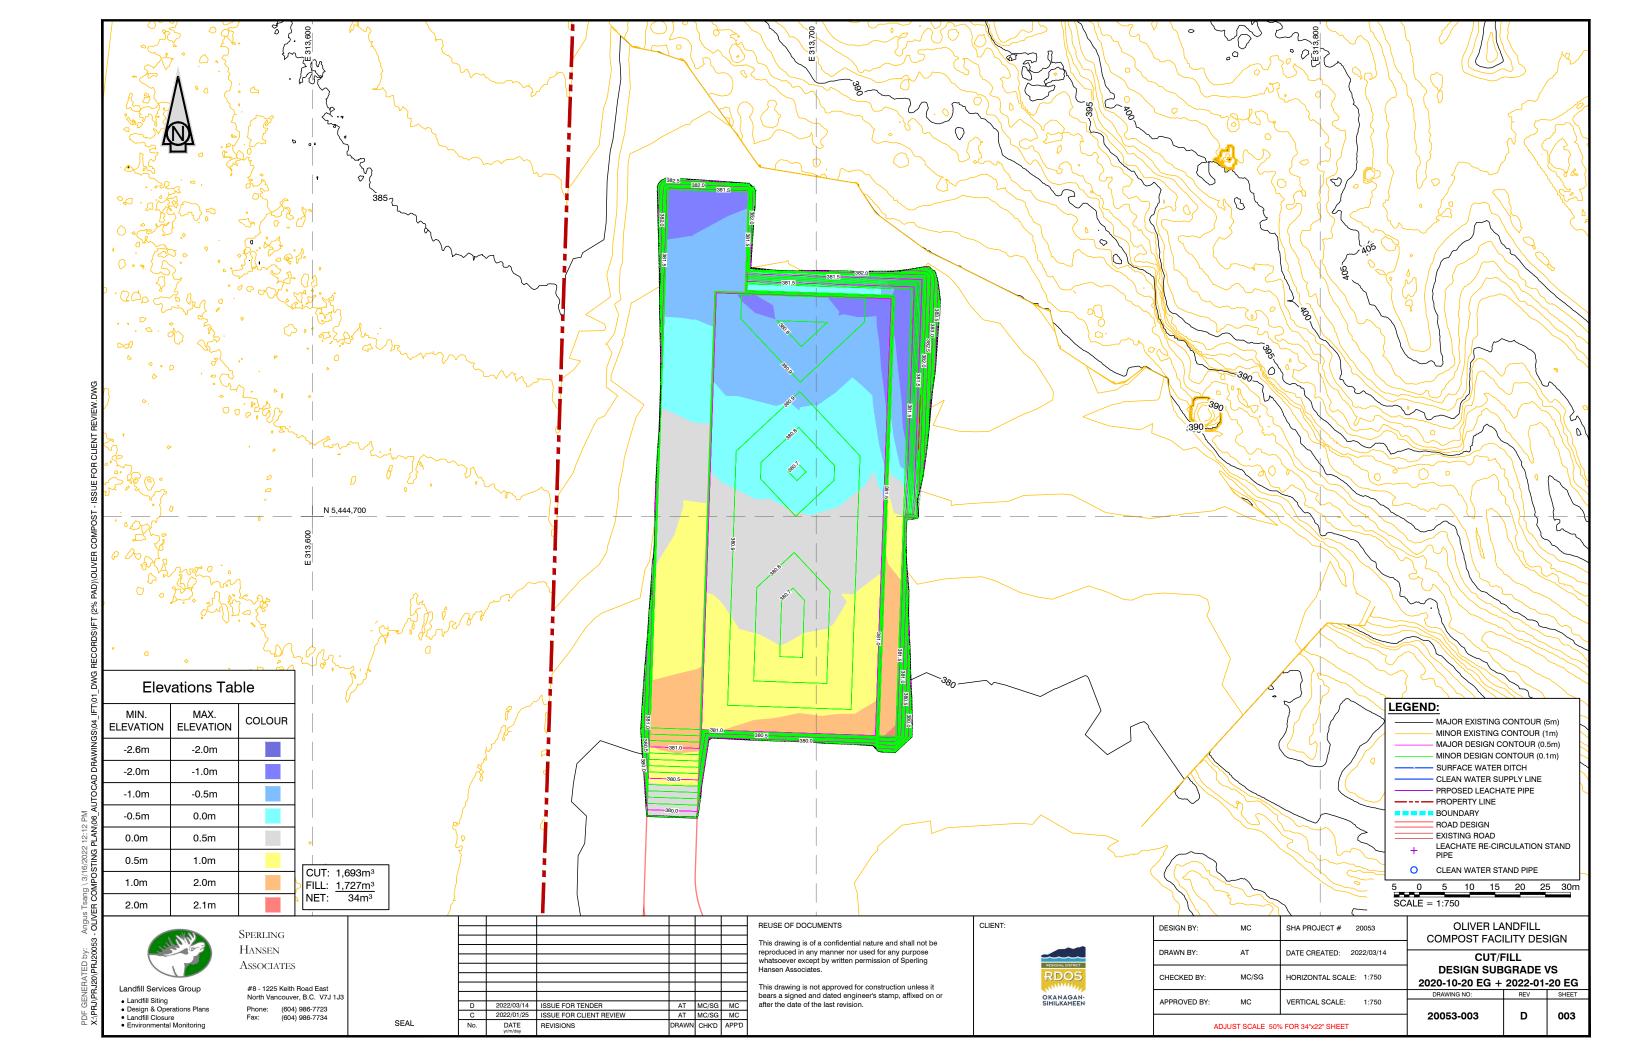

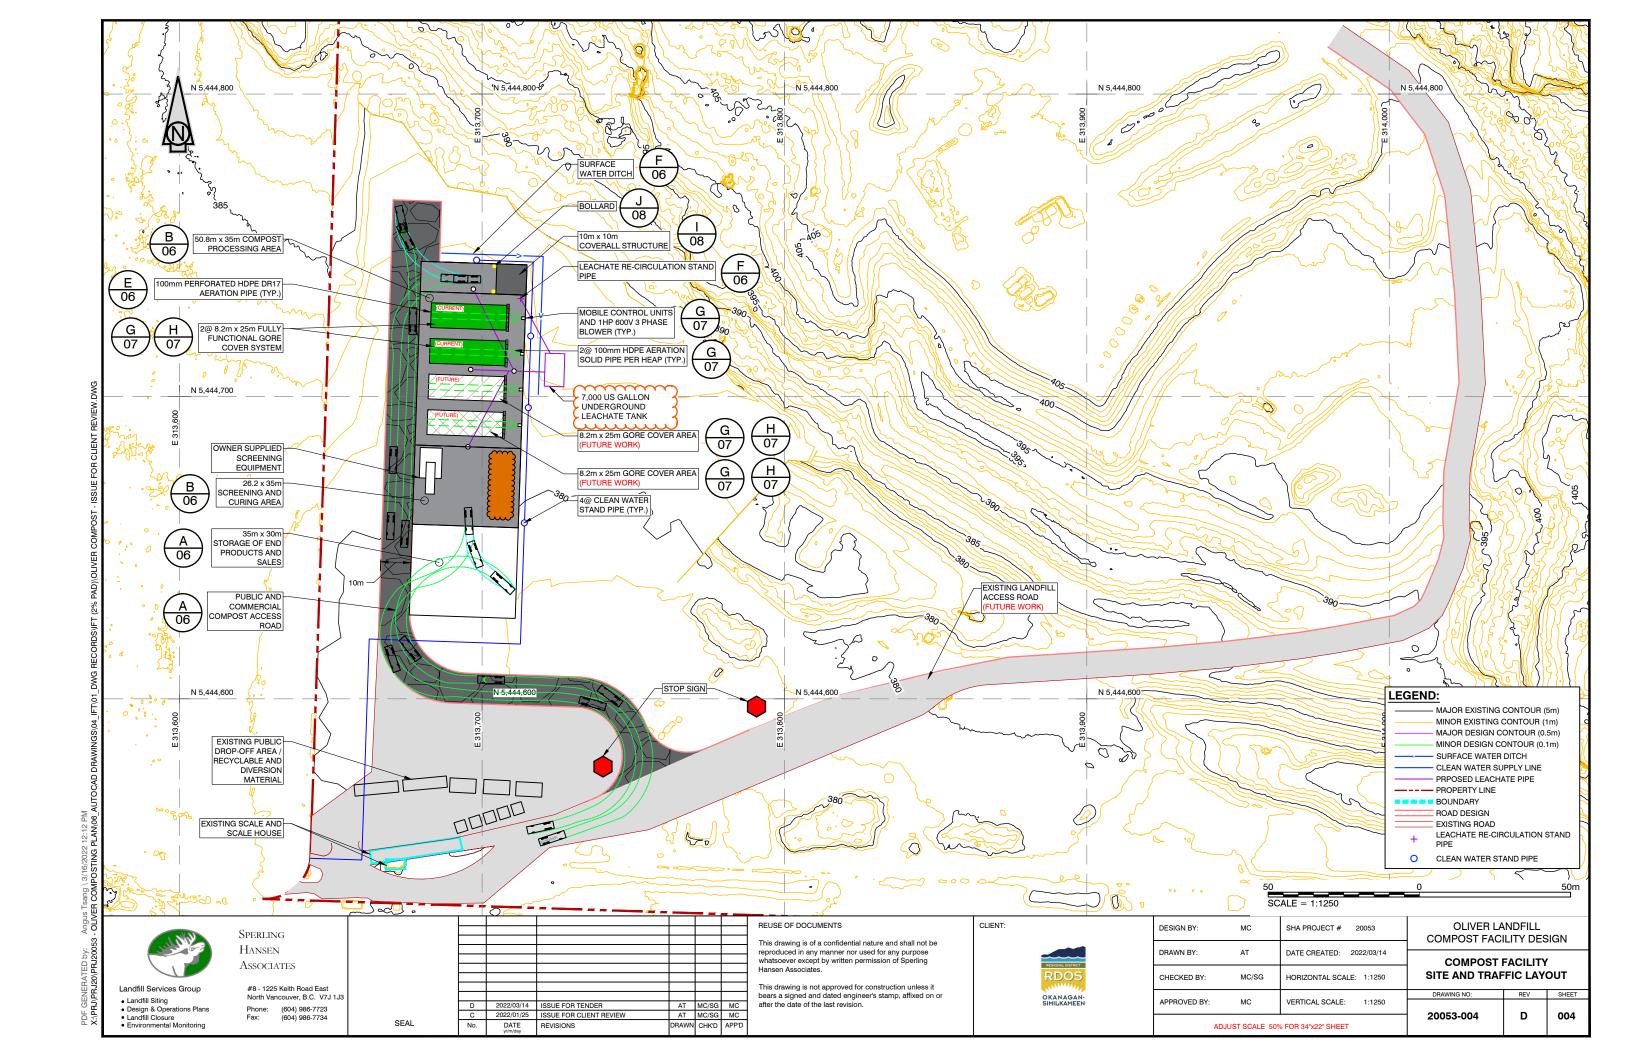

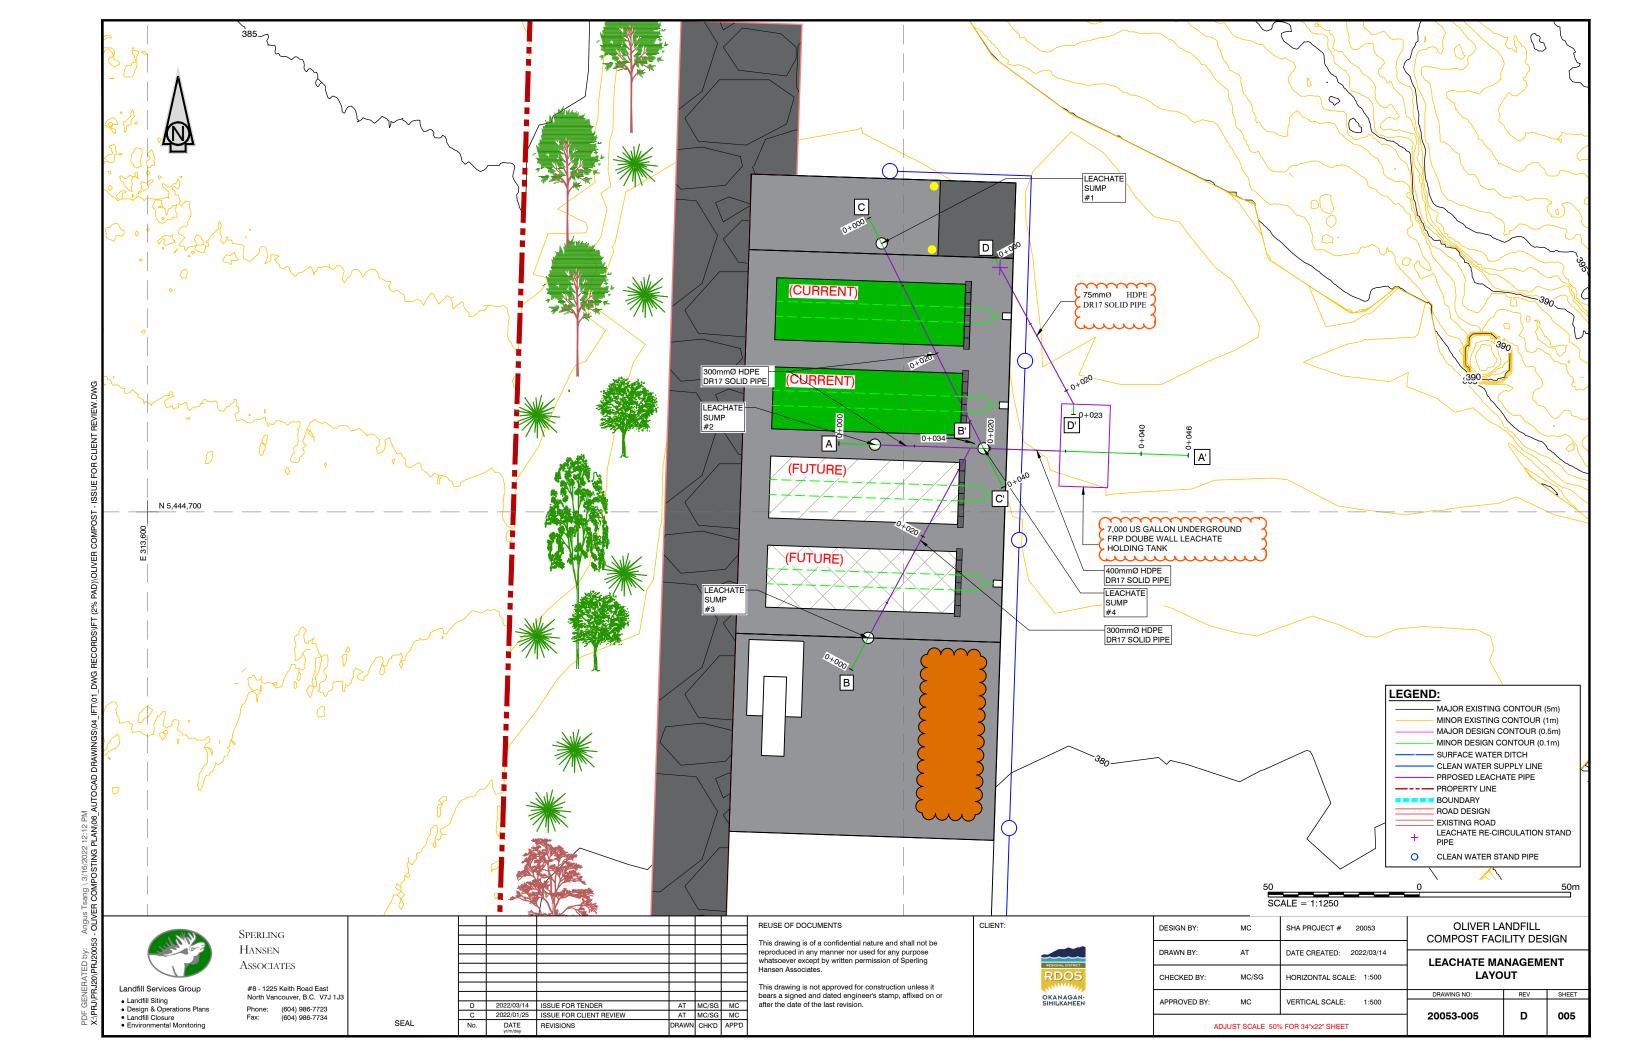

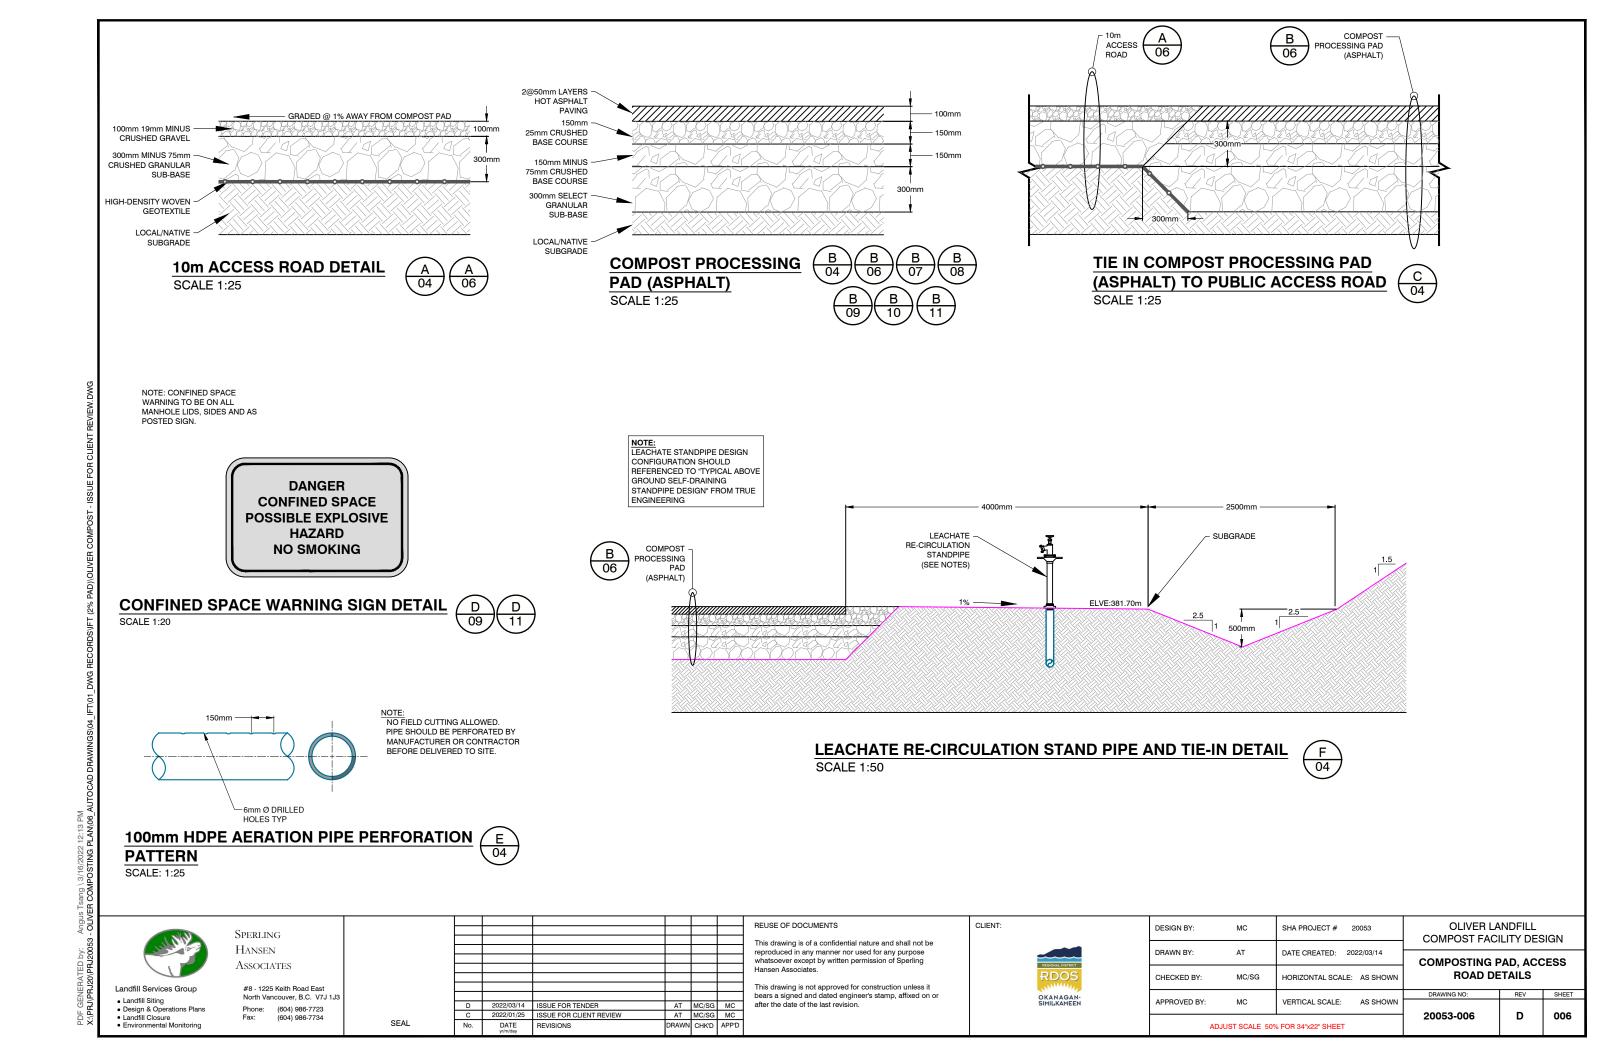

This drawing is of a confidential nature and shall not be

This drawing is not approved for construction unless it bears a signed and dated engineer's stamp, affixed on or after the date of the last revision.

reproduced in any manner nor used for any purpose whatsoever except by written permission of Sperling

Hansen Associates.

AT MC/SG MC

AT MC/SG MC

DRAWN CHK'D APP'D

ISSUE FOR TENDER

2022/01/25 ISSUE FOR CLIENT REVIEW

REVISIONS

DATE

DESIGN BY:

DRAWN BY:

CHECKED BY:

APPROVED BY:

OKANAGAN-SIMILKAMEEN

MC/SG

ADJUST SCALE 50% FOR 34"x22" SHEET

MC

SHA PROJECT # 20053

VERTICAL SCALE:

DATE CREATED: 2022/03/14

HORIZONTAL SCALE: AS SHOWN

AS SHOWN

COMPOST FACILITY DESIGN

GORE COMPOSTING

DETAILS

D

SHEET

007

DRAWING NO:

20053-007

Landfill Services Group

Design & Operations Plans
Landfill Closure
Environmental Monitoring

Landfill Siting

Sperling


Hansen

Associates

#8 - 1225 Keith Road East North Vancouver, B.C. V7J 1J3

(604) 986-7723 (604) 986-7734

SEAL

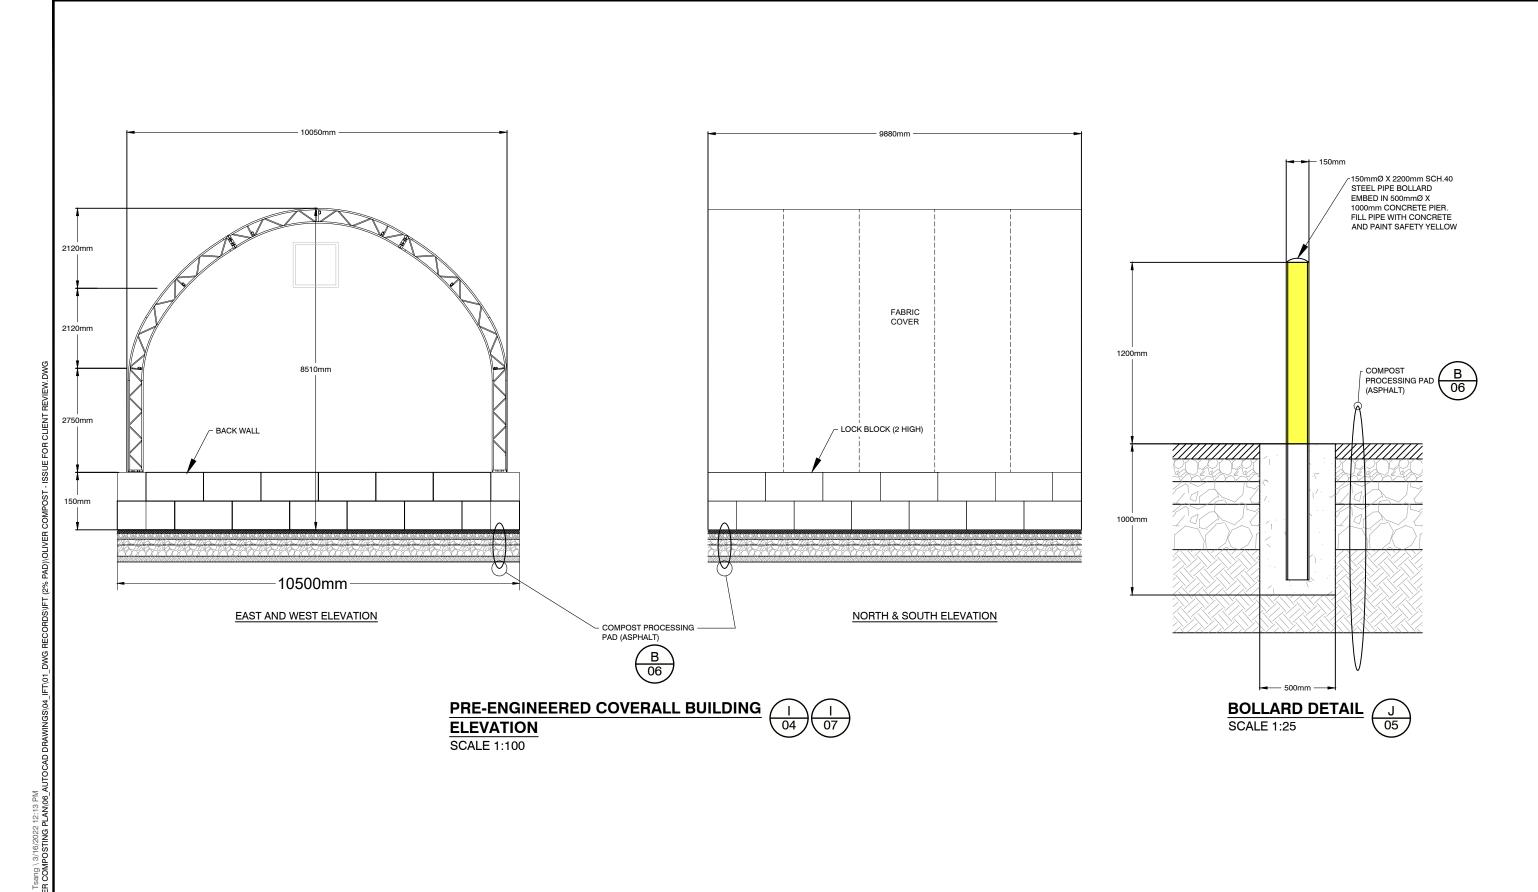



Sperling Hansen

Landfill Siting
 Design & Operations Plans
 Landfill Closure
 Environmental Monitoring

Associates

#8 - 1225 Keith Road East North Vancouver, B.C. V7J 1J3 (604) 986-7723 (604) 986-7734

SEAL

]
						1
						1
						1
						1
						1
						1
						1
D	2022/03/14	ISSUE FOR TENDER	AT	MC/SG	MC	1
С	2022/01/25	ISSUE FOR CLIENT REVIEW	AT	MC/SG	MC	1
No.	DATE yr/m/day	REVISIONS	DRAWN	CHK'D	APP'D	

REUSE OF DOCUMENTS

This drawing is of a confidential nature and shall not be reproduced in any manner nor used for any purpose whatsoever except by written permission of Sperling Hansen Associates.

This drawing is not approved for construction unless it bears a signed and dated engineer's stamp, affixed on or after the date of the last revision.

REGIONAL DISTRICT	
RDOS	
"There's	
OKANAGAN- SIMILKAMEEN	

CLIENT:

ESIGN BY:	МС	SHA PROJECT # 20053	OLIVER LANDFILL COMPOST FACILITY DESIGN PRE-ENGINEERED COVERALL BUILDING AND BOLLARD DETAIL		SIGN
PRAWN BY:	AT	DATE CREATED: 2022/03/14			
CHECKED BY:	MC/SG	HORIZONTAL SCALE: AS SHOWN			
			DRAWING NO:	REV	SHEET
APPROVED BY:	MC	VERTICAL SCALE: AS SHOWN			
ADJUST SCALE 50% FOR 34"x22" SHEET			20053-008	D	800

STA. 0+000 TO STA. 0+046.23 1200mmØ LEACHATE ¬ SUMP #4 WITH LEACHATE TANK VENT - SURFACE WATER (D) (06) EXPLOSION PROOF CONFINED SPACE LID DITCH -382 - 300mmØ HDPE DR17 SOLID PIPE@3.9% - 400mmØ HDPE DR17 SOLID PIPE@2% -380 TEE COLLECTION OF 300mmØ HDPE -DR17 SOLID PIPE INV ELEV: 379.26m INV ELEV: -379.21m -378 300mmØ HDPE DR17 - INV ELEV: SOLID PIPE INV ELEV:379.30m PRE-FABRICATED MANHOLE BASE - 100mm MINUS 25mm · CRUSHED GRAVEL DOUBLED WALL -376 LEACHATE TANK



Landfill Services Group

Landfill Siting
 Design & Operations Plans
 Landfill Closure
 Environmental Monitoring

Sperling HANSEN Associates

В

06

COMPOST

382-

380-

378-

376

0+000.00

PROCESSING

PAD (ASPHALT)

PRE-FABRICATED --MANHOLE BASE

- 1200mmØ MANHOLE LEACHATE SUMP #1

└─ INV ELEV: 379.72m

#8 - 1225 Keith Road East North Vancouver, B.C. V7J 1J3 (604) 986-7723 (604) 986-7734

SEAL

AT MC/SG MC AT MC/SG MC D 2022/03/14 ISSUE FOR TENDER 2022/01/25 ISSUE FOR CLIENT REVIEW DATE vr/m/day DRAWN CHK'D APP'D REVISIONS

REUSE OF DOCUMENTS

This drawing is of a confidential nature and shall not be reproduced in any manner nor used for any purpose whatsoever except by written permission of Sperling

0+025.00

A-A' PROFILE

This drawing is not approved for construction unless it bears a signed and dated engineer's stamp, affixed on or after the date of the last revision.

REGIONAL DISTRICT	
RDOS	
OKANACAN	
OKANAGAN- SIMILKAMEEN	


CLIENT:

TYP. PRECAST CONCRETE
DEADMEN WITH HOLD DOWN STRAP

DESIGN BY:	МС	SHA PROJECT # 20053	OLIVER LANDFILL COMPOST FACILITY DESIGN		SIGN
DRAWN BY:	AT	DATE CREATED: 2022/03/14			
CHECKED BY:	MC/SG	HORIZONTAL SCALE: 1:125	SECTION A-A'		
			DRAWING NO:	REV	SHEET
APPROVED BY:	MC UST SCALE 509	VERTICAL SCALE: 1:125 % FOR 34"x22" SHEET	- 20053-009 D 00		009

-374

0+046.23

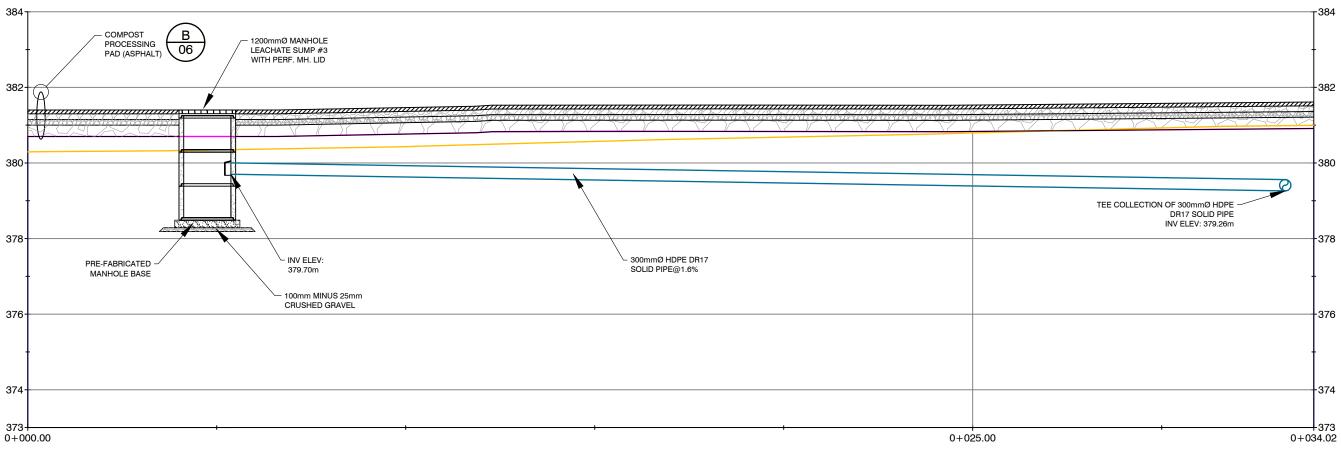



Sperling Hansen

Landfill Siting
 Design & Operations Plans
 Landfill Closure
 Environmental Monitoring

Associates

#8 - 1225 Keith Road East North Vancouver, B.C. V7J 1J3 (604) 986-7723 (604) 986-7734

SEAL

С						
Г						
Г						
Γ						
Г						
Г						
Г	D	2022/03/14	ISSUE FOR TENDER	AT	MC/SG	MC
Г	С	2022/01/25	ISSUE FOR CLIENT REVIEW	AT	MC/SG	MC
	No.	DATE yr/m/day	REVISIONS	DRAWN	CHK'D	APP'D

REUSE OF DOCUMENTS


This drawing is of a confidential nature and shall not be reproduced in any manner nor used for any purpose whatsoever except by written permission of Sperling Hansen Associates.

This drawing is not approved for construction unless it bears a signed and dated engineer's stamp, affixed on or after the date of the last revision.

REGIONAL DISTRICT	
RDOS	
OKANAGAN- SIMILKAMEEN	

CLIENT:

DESIGN BY:	МС	SHA PROJECT # 20053	OLIVER LANDFILL COMPOST FACILITY DESIGN		SIGN
DD 41401 DV					
DRAWN BY:	AT	DATE CREATED: 2022/03/14			
			0505101		
CHECKED BY:	MC/SG	HORIZONTAL SCALE: 1:100	SECTIO	M R-R.	
			DRAWING NO:	REV	SHEET
APPROVED BY:	MC	VERTICAL SCALE: 1:100			
			20053-010	ם ו	010
AD II	ICT COALE FO	% FOR 34"x22" SHEET	20033-010	ן פ	010
ADJU	JST SCALE 50	% FUR 34 X22 SHEET			

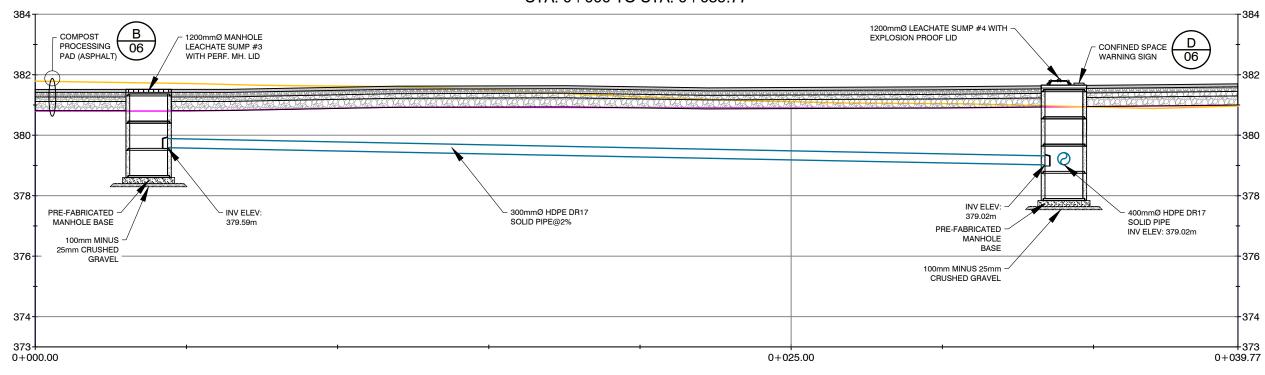



Hansen

Landfill Siting
 Design & Operations Plans
 Landfill Closure
 Environmental Monitoring

Sperling Associates

#8 - 1225 Keith Road East North Vancouver, B.C. V7J 1J3 (604) 986-7723 (604) 986-7734

SEAL

D	2022/03/14	ISSUE FOR TENDER	AT	MC/SG	MC
С	2022/01/25	ISSUE FOR CLIENT REVIEW	AT	MC/SG	MC
No.	DATE yr/m/day	REVISIONS	DRAWN	CHK'D	APP'D

REUSE OF DOCUMENTS

This drawing is of a confidential nature and shall not be reproduced in any manner nor used for any purpose whatsoever except by written permission of Sperling Hansen Associates.

This drawing is not approved for construction unless it bears a signed and dated engineer's stamp, affixed on or after the date of the last revision.

REGIONAL DISTRICT	
RDOS	
OKANACAN	
OKANAGAN- SIMILKAMEEN	

CLIENT:

ESIGN BY:	МС	SHA PROJECT # 20053	OLIVER LANDFILL COMPOST FACILITY DESIGN		IGN
RAWN BY:	AT	DATE CREATED: 2022/03/14	SECTION C-C'		
HAWN DI.	Ai	DATE CREATED: 2022/03/14			
HECKED BY:	MC/SG	HORIZONTAL SCALE: 1:125			
			DRAWING NO:	REV	SHEET
PPROVED BY:	MC	VERTICAL SCALE: 1:125		_	
ADJUST SCALE 50% FOR 34"x22" SHEET		20053-011	D	011	

Landfill Services Group

Landfill Siting
 Design & Operations Plans
 Landfill Closure
 Environmental Monitoring

Associates

#8 - 1225 Keith Road East North Vancouver, B.C. V7J 1J3 (604) 986-7723 (604) 986-7734

SEAL

AT MC/SG MC AT MC/SG MC D 2022/03/14 ISSUE FOR TENDER C 2022/01/25 ISSUE FOR CLIENT REVIEW DATE vr/m/day DRAWN CHK'D APP'D REVISIONS

Hansen Associates.

This drawing is not approved for construction unless it bears a signed and dated engineer's stamp, affixed on or after the date of the last revision.

REGIONAL DISTRICT	
RDOS	
OKANAGAN- SIMILKAMEEN	

DESIGN BY:	MC	SHA PROJECT # 20053	OLIVER LANDFILL COMPOST FACILITY DESIGN		SIGN
DRAWN BY:	AT	DATE CREATED: 2022/03/14	LEACHATE SYSTEM		· · · · · · · · · · · · · · · · · · ·
CHECKED BY:	MC/SG	HORIZONTAL SCALE: NTS	SCHEMATICS		l
			DRAWING NO:	REV	SHEET
APPROVED BY: MC		VERTICAL SCALE: NTS	20050 040		040
ADJUST SCALE 50% FOR 34"x22" SHEET			20053-012	D	012



Appendix B

Revised Instructions to Tenderers Part 1(reflecting revisions from Addendum #1)

2009

1.0	Introduction	IT - 1
2.0	Tender Documents	IT - 2
3.0	Submission of Tenders	IT - 3
4 0	Additional Instructions to Tenderers	IT _ <i>1</i>

THIS PAGE INTENTIONALLY LEFT BLANK

IT - PART I IT - 1 2009

(FOR USE WHEN UNIT PRICES FORM THE BASIS OF PAYMENT TO BE USED ONLY WITH THE GENERAL CONDITIONS AND OTHER STANDARD DOCUMENTS OF THE UNIT PRICE MASTER MUNICIPAL CONSTRUCTION DOCUMENTS.)

(TO BE READ WITH "INSTRUCTIONS TO TENDERERS - PART II" CONTAINED IN THE EDITION OF THE PUBLICATION "MASTER MUNICIPAL CONSTRUCTION DOCUMENTS" SPECIFIED IN ARTICLE 2.2 BELOW)

Owner: Regional District of Okanagan-Similkameen

(NAME OF OWNER)

Contract: Construction Services for the Oliver Landfill Organics Composting Facility

(TITLE OF CONTRACT)

Reference No. RDOS-22-ENG-05

(OWNER'S CONTRACT REFERENCE NO.)

1.0 Introduction

1.1 These Instructions apply to and govern the preparation of tenders for this *Contract*. The *Contract* is generally for the following work but not limited to:

- Earthworks & Site Regrading: The Contractor is required to clear, grub, strip soil, prepare site for construction of composting pad, water service, lock block, drainage and roads.
- 2. Composting Facility: The Contractor is required to supply and install the Dome structure, construct leachate management system, prepare subgrade and pave, and place piping and conduit for water, electrical, and leachate. The Contractor is required to supply and install various mechanical systems including but not limited to leachate collection and disposal sumps/pumps and tank.
- 3. Electrical: The Contractor is required to construct general misc. electrical systems for lighting and mechanical equipment. The Contractor is required to commission, test and provide necessary manuals and training for systems.
- 4. Miscellaneous: The Contractor is required to complete some miscellaneous works including landscaping, signage, testing and QA/QC for paving works, and more.

(BRIEF DESCRIPTION OF THE WORK)

1.2 Direct all inquiries regarding the *Contract*, to:

Scott Garthwaite, AScT, Project Manager with Cc to Shane Fenske, AScT

(NAME AND POSITION OF INDIVIDUAL WHO WILL ANSWER INQUIRIS)

Address: Sperling Hansen Associates Inc.

1332 McGill Rd,

Kamloops, BC V2C 6N6

Phone: 604 803 - 7120

Email: <u>sgarthwaite@sperlinghansen.com</u>

Address: Regional District of Okanagan Similkameen

101 Martin Street,

Penticton, BC V2A 5J9

Phone: 250 490 - 4117

Email: sfenske@rdos.bc.ca

The deadline for submitting inquiries is **Friday April 29, 2022, at 4:00 pm.**

2.0 Tender Documents

2.1

- The tender documents which a tenderer should review to prepare a tender which consists of all of the *Contract Documents* listed in Schedule 1 entitled "Schedule of Contract Documents". Schedule 1 is attached to the Agreement which is included as part of the tender package. The *Contract Documents* include the drawings listed in Schedule 2 to the Agreement, entitled "List of *Contract Documents*".
- 2.2 A portion of the Contract Documents are included by reference. Copies of these documents have not been included with the tender package. These documents are the Instructions to Tenderers Part II, General Conditions, Specifications and Standard Detail Drawings. They are those contained in the publication entitled "Master Municipal Construction Documents General Conditions, Specifications and Standard Detail Drawings". Refer to Schedule 1 to the Agreement or, if not specified in Schedule 1, then the applicable edition shall be the most recent edition as of the date of the Tender Closing Date. All sections of this publication are by reference included in the Contract Documents.
- 2.3 Any additional information made available to tenderers prior to the Tender Closing Time by the Owner or representative of the Owner, such as geotechnical reports or as-built plans, which is not expressly included in Schedule 1 or Schedule 2 to the Agreement, is not included in the Contract Documents. Such additional information is made available only for the assistance of tenderers who must make their own judgment about its reliability, accuracy, completeness and relevance to the Contract, and neither the Owner nor any representative of the Owner gives any guarantee or representation

unopened.

2009

- 4.1 Total Performance is expected on or before November 1, 2022.
- 4.2 Substantial Performance is expected on or before October 15, 2022.
- 4.3 Notice of Award is expected on May 27, 2022.
- 4.4 Notice to Proceed is expected on June 10, 2022.

These Supplemental Instructions to Tenderers modify the MMCD Instructions to Tenderers - Part II in the following sections:

- 4.5 IT 5.3 is amended by adding the following after IT 5.3.5:
 - 5.3.6 Appendix 6 List of Available Equipment Owned by the Contractor.
- 4.6 IT 6.2 and 6.3 are deleted.
- 4.7 The following will replace IT 8.1:
 - 8.1(a) Subject to the current federal and provincial health restrictions with respect to the COVID-19 pandemic, a **mandatory visit** by tenderers to the Place of the Work is scheduled for **9:00 a.m. on April 12, 2022.** Representatives of the Owner and Contract Administrator will be in attendance. It is recommended that all tenderers attend the **mandatory** site visit. It is anticipated that answers to questions that are made at the **mandatory** site visit will be distributed through an Addendum. The holding of the **mandatory** visit in no way limits the responsibility of tenderers under paragraph 8.1 of these Instructions to Tenderers Part II or otherwise to have inspected the Place of the Work.
- 4.8 Award of the Contract is subject to the approval of the Board of Directors.
- 4.9 Award of the Contract is subject to funds being legally available for the project.
- 4.10 The Contractor will provide all construction layouts. Digital files will be provided by the Owner or Consultant for layout purposes.
- 4.11 All materials and density testing, including granular materials and compaction tests, will be arranged by and paid for by the Contractor. The Contractor is responsible for ensuring all materials meet MMCD specifications and any Supplementary Specifications. Where initial tests fail and subsequent testing is considered necessary by the Contract Administrator, the subsequent testing will be arranged by and paid for by the Contractor.
- 4.12 The Owner reserves the right to reject any or all tenders or to accept any tender should it be considered in the interest of the Owner to do so. The lowest of any tender will not necessarily be accepted and the Owner reserves the right to negotiate with any bidder.

UNIT		IT – Part I
PRICE		IT - 5
CONTRACT	Instructions to Tenderers Part I	2009



Appendix C

Revised Schedule A Supplementary General Conditions (reflecting revisions from Addendum #1)

FORM OF AGREEMENT PAGE 1 OF 6

Schedule A

8.2 SUPPLEMENTARY GENERAL CONDITIONS

SGC.1 HOURS OF WORK; WORK AREAS

The Contractor must comply at all times with the Regional District of Okanagan-Similkameen (RDOS or Regional District) Noise Control By-Law and verify the hours within which construction work may be performed. No work noise shall be created except as permitted by all applicable RDOS by-laws.

The Regional District's forces work at the Oliver Landfill (the Landfill Site) between the hours of 10:00 A.M. and 3:45 P.M. Monday through Saturday (March to end of November) and 12:00 PM to 3:45 PM Monday through Friday, and 10:00 AM to 3:45 PM on Saturdays (December to end of February), Sundays or "holidays" as defined in the Employment Standards of British Columbia). Work will not be performed by RDOS forces or RDOS inspectors outside these hours except by special arrangement agreed to by the Consultant or in case of an emergency. The Consultant will be made available for all critical stages in accordance with notification requirements. Where deemed necessary, work performed in the absence of a required inspection is not permitted. Notwithstanding any other provision hereof, the District shall not pay overtime labour rates to the Contractor (for example, but without limitation, in relation to any Force Account Work), unless the payment of overtime has been specifically approved in writing by the RDOS, and the Contractor hereby acknowledges that such overtime labour and equipment rates shall only be considered by the RDOS if the Contractor is required to work in excess of ten (10) hours per day or in excess of six days per week to complete the Work.

The Contractor will have unrestricted access to the landfill for the duration of the project. The Contractor will be provided 2 keys for the landfill gate at the project kickoff meeting.

SGC.2 WORK WITH CONSULTANT AND COORDINATION ON SITE

The Work shall be done in accordance with the Contract Documents and to the satisfaction of the Contract Administrator (also referred to in the Contract Documents as "Engineer" and "Owner's Representative"). The Contractor shall coordinate the Work with the Contract Administrator, the Owner and other contractors, as necessary. The Contractor shall have no cause for claim against the Regional District whatsoever with respect to delays or other interruption of the Work by the Regional District forces or due to the above requirement to coordinate the Work with the Contract Administrator, the Owner and other contractors.

Unit		FORM OF AGREEMENT
PRICE	FORM OF AGREEMENT - SCHEDULE A	Page 2 of 6
CONTRACT	SUPPLEMENTARY GENERAL CONDITIONS	

The Contractor will be responsible for completing the Work in a way that does not hinder other work on the Landfill Site being conducted either by the Regional District or third parties. The Contractor will have no cause for claim against the Regional District whatsoever with respect to delays or other interruption of the Work due to the above requirement to complete the Work in a way that does not hinder other work on the Landfill Site.

The Contractor will have unrestricted access to the Landfill for the duration of the Project. The Contractor will be provided with 2 sets of keys for the Landfill Gate.

Notwithstanding any other provision hereof, it is expressly hereby agreed that the Contractor's rights to access the Landfill Site shall at all times be subordinated to the rights of other contractors already performing operations at the Landfill Site as of the date of the Agreement.

SGC.3 DESIGN AND INSPECTION

The Consultant has been hired by the Regional District as the Contract Administrator, consultant to complete the Specifications and Drawings, be the payment certifier and conduct inspections during the performance of the Work. The Contractor must allow inspectors from the Consultant and the Regional District to perform their reviews and inspections during the Work so that all design standards, specification requirements, quantities and prices may be independently verified.

SGC.4 TRAFFIC MANAGEMENT AND COORDINATION

The Contractor will not use the Site for the parking of its employees or other vehicles, except for those actively and reasonably required for the performance of the Work. Vehicle traffic within the Site must be limited to Work purposes, such as grading, staging and delivery. All Work shall be in full compliance with WorkSafeBC requirements and guidelines.

The Traffic Control Plan shall be approved by the Engineer prior to commencing any Work.

SGC.5 TRUCK SAFETY

All truck operators must comply with the Regional District by-laws regulating truck use, including truck route, engine brake noise, and weight and load securement provisions, and must also obey the posted speed limits at the Oliver Landfill.

SGC.6 CONSTRUCTION DURING INCLEMENT WEATHER

In accordance with the Specifications, placement, compaction and/or installation of materials shall not be conducted while it is raining or snowing, when ground conditions are wet, or in poor sub-grade conditions, unless approved by the Consultant.

The Consultant may order the Contractor to cease certain operations due to inclement weather at any time.

There will be no extensions to the Construction Schedule granted and no extra compensation payable on account of delays caused by inclement weather. Any costs incurred by the Contractor to accelerate the Work in order to achieve the Construction Schedule will be borne solely by the Contractor.

SGC.7 DUST AND ODOUR CONTROL

The Contractor shall at all times control the generation of dust by its operations by water sprinkling or by other methods approved by the Contract Administrator. There is no available water supply at the Oliver Landfill. The Contractor is also responsible for regular maintenance on the Work Site and any attributable road cleanliness on the Landfill Site and adjacent public roads, including but not limited to road sweeping and vehicle washing, in order to reduce any accumulated dust and other debris.

SGC.8 SUBSURFACE CONDITIONS

The Contractor now acknowledges that it is experienced and familiar with assessing and working with the variable and unpredictable nature of compacted landfill waste and unknown material and sub-surface conditions and acknowledges that the Owner has made available to the Contractor all available information concerning the relatively unknown state of decomposition, compaction, and composition of the residential, commercial and industrial waste, demolition material, and other matter comprising the subject matter of the Work. The Contractor now assumes all risks of any kind or nature associated with performing the Work on and in landfill waste, whether or not such risks arise due to the reasonably foreseeable consequences of working in and around landfill waste, and whether or not such risks are the result of sub-surface conditions which were not known to the Contractor at the time of submitting the Contractor's Tender, and the Contractor now agrees not to make any claim for an extension of Contract Time or additional compensation for anything arising during the Contract which would not have occurred but for the existence of landfill waste.

The Contractor shall be solely and fully responsible to take all necessary measures to protect underground utilities from any excavation damage within the worksite. The Owner has indicated the presence of underground utilities (underground facilities) known

Unit		FORM OF AGREEMENT
PRICE	FORM OF AGREEMENT - SCHEDULE A	Page 4 of 6
CONTRACT	SUPPLEMENTARY GENERAL CONDITIONS	

to be within the proposed area of excavation on the Construction Drawings issued for Tender. The location of underground utilities as identify in the Drawings shall be considered approximate and for information only. The underground utilities include, but not limited to fiber optic cables, pump discharge force mains, electrical conduits and cables, water and sewage pipes. Irrespective of the depth of the utility line, the Contractor must not use mechanical excavating equipment to dig within the boundary limits to expose the utility line. Hydrovac excavation or equivalent can be used as an alternative to hand digging.

SGC.9 ENVIRONMENTAL PROTECTION AND SUSTAINABILITY

The Contractor shall give prime consideration to protecting the environment during all stages of construction and shall cooperate fully with Owner, Consultant, Site operating personnel, and appropriate authorities to protect the natural environment.

Inspectors from the Ministry of Environment and Climate Change Strategy (ENV) and other authorities having jurisdiction may make periodic visits to the Site during construction. They have the authority to order the Contractor to stop work if in their opinion work is not being completed in accordance with existing regulations and approvals applicable to Work. The Contractor must provide at all times proper facilities for safe access to the Work by authorized government officials.

The Contractor will provide environmentally sensitive products or services wherever possible. Where the Contract Documents require that the Contractor supply materials, and where such materials may cause adverse effects, the Tenderer is to notify the Consultant of the nature of the hazard. The Contractor is to advise the Consultant of any known alternatives or substitutes for such materials that would mitigate the effects of any adverse conditions on the environment.

SGC.10 COMPLIANCE WITH LAWS

The Contractor will complete the Work in accordance with the requirements of all Applicable Laws.

The Contractor will be required to obtain and pay for any applicable municipal, provincial and federal permits and licenses necessary for the proper completion of the Work. The Regional District will not be liable in any manner for the same and the Contractor agrees to indemnify and save the Regional District from and against all claims and Losses in relation to obtaining and paying for any applicable municipal, provincial and federal permits and licenses necessary for the proper completion of the Work. Extra

Unit		FORM OF AGREEMENT
PRICE	FORM OF AGREEMENT - SCHEDULE A	Page 5 of 6
CONTRACT	SUPPLEMENTARY GENERAL CONDITIONS	

compensation will not be allowed for costs incurred by the Contractor as a result of the failure of the Regional District or the Contractor to secure construction permits such that the Contractor can proceed with the Work in accordance with the Construction Schedule.

SGC.11 PRICING

The Tendered Price will represent the entire cost excluding GST to the Owner of the complete Work based on the estimated quantities in the Schedule of Quantities and Prices of the Form of Tender. Notwithstanding the generalities of the above, tenderers shall include in the tendered prices (including unit prices, lump sum prices, or other forms of pricing) sufficient amounts to cover:

- (a) The cost of all labour, equipment and material included in or required for the Work, including all items which, while not specifically listed in the Schedule of Quantities and Prices, are included in the Work specifically or by necessary inference
- (b) from the Contract Documents;
- (c) All assessments payable with respect to labour as required by any statutory scheme such as unemployment insurance, holiday pay, insurance, CPP and all employee benefits and the Workers Compensation Act;
- (d) All overhead costs, including head office and on-site overhead costs, and all amounts for the Contractor's profit.

The tendered prices and all subcontracts must allow for compliance with all applicable laws regarding trade or other qualifications of employees performing the Work, and payment of appropriate wages for labour included in or required for the Work.

SGC.12 QUANTITY VARIATION

If for any reason, including an addition or deletion of work, the actual quantity of a unit price item listed in the Schedule of Quantities and Prices varies, neither the Contractor nor the Owner shall be entitled to unilaterally revise the unit price of said item. The unit rates set out in the Schedule of Quantities and Prices shall be considered fixed unless a mutual agreement in writing is reached.

SGC.13 VARIANCE THRESHOLD PERCENTAGE

GC 1.76 "Variance Threshold Percentage" is 15%

·		
Unit		FORM OF AGREEMENT
PRICE	FORM OF AGREEMENT - SCHEDULE A	Page 6 of 6
CONTRACT	SUPPLEMENTARY GENERAL CONDITIONS	

SGC.14 DAMAGES TO OTHER CONTRACTORS

If in the performance of the Work the Contractor causes damages to another Contractor, the Contractor shall use best reasonable efforts to reach a settlement with the Other Contractor. If another Contractor commences litigation or arbitration proceedings against the Owner on account of damage that the Other Contractor alleges was caused by the Contractor, then the Owner shall so notify the Contractor in writing. On written demand from the Owner, the Contractor shall, at the Contractor's own expense, reasonably cooperate with the Owner in the defence of the Other Contractor's claim, or assume the entire defence of the Owner. If a final order or judgement is given in such litigation or proceeding against the Owner the Contractor shall pay or satisfy it and pay all defence costs reasonably incurred by the Owner.

SGC.15 WILDFIRE PREVENTION AND MITIGATION

The Contractor will be responsible at its own cost to comply with the Wildfire Act and perform its activity in such manner to reduce the risk of wildfires and to minimize the impact if a wildfire does occur. As soon as the Fire Danger Rating as defined by the Canadian Forest Fire Danger Rating System is above Moderate, the Contractor will be responsible to supply and maintain at its own cost, for as long as needed, fire suppression equipment consisting of mobile water supply apparatus complete with high flow water pump. The Contractor will be responsible at its own cost to bring water to site for construction purposes, dust and fire suppression.