10230-81ST ST-OSOYOOS, BC

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A0.2 Impermeable Area Plan

A1.1 Main Floor Plan

A1.2 Upper Floor Plan

SITE PLAN:

PROJECT	BYLAW REVIEW
Zoning:	AG2
Proposal:	Single Family & Secondary Suite
Civic Address:	10230- 81st St
Legal Description:	Lot 1, DL 2450s, SDYD, Plan epp87173

Lot Area: 16,648 sf (1,546.6 m2-0.15466ha)

				Permitted	Proposed
LOOR	AREA:		Site Coverage:	35% = 5,826.8 sf	14.39% = 2,395 9
	UPPER FLOOR:	808.8 sf	Front setback:	7.5 m	33.98 m
	MAIN FLOOR:	<u>1797.6 sf</u>	Rear setback:	7.5 m	7.62 m
TOTAL I	PROPOSED AREA:	2606.4 sf	Interior Side setback:	1.5 m	2.09 m
PORCHE	ES AREA:	234.5 sf	Exterior Side setback:	4.5 m	5.37 m
			Building Height:	10.0 m	6.7 m

PROJECT TEAM:

Architectural Consultant	Structural Consultant
Devise Design	Ravi singh Engineering
a I #220, 275 E 1st Ave, Vancouver, BC	e I singhravi1969@outlook.c
p 778.379.9636	-
e l info@devisedesian.ca	

Surveyor:

Pendergraft Professional Land Surveying Inc.

a I box 640 osoyoos, b.c. voh 1vo

p I 250 495 7127

e I brock@pendergraftsurveying.ca

d e i s i g

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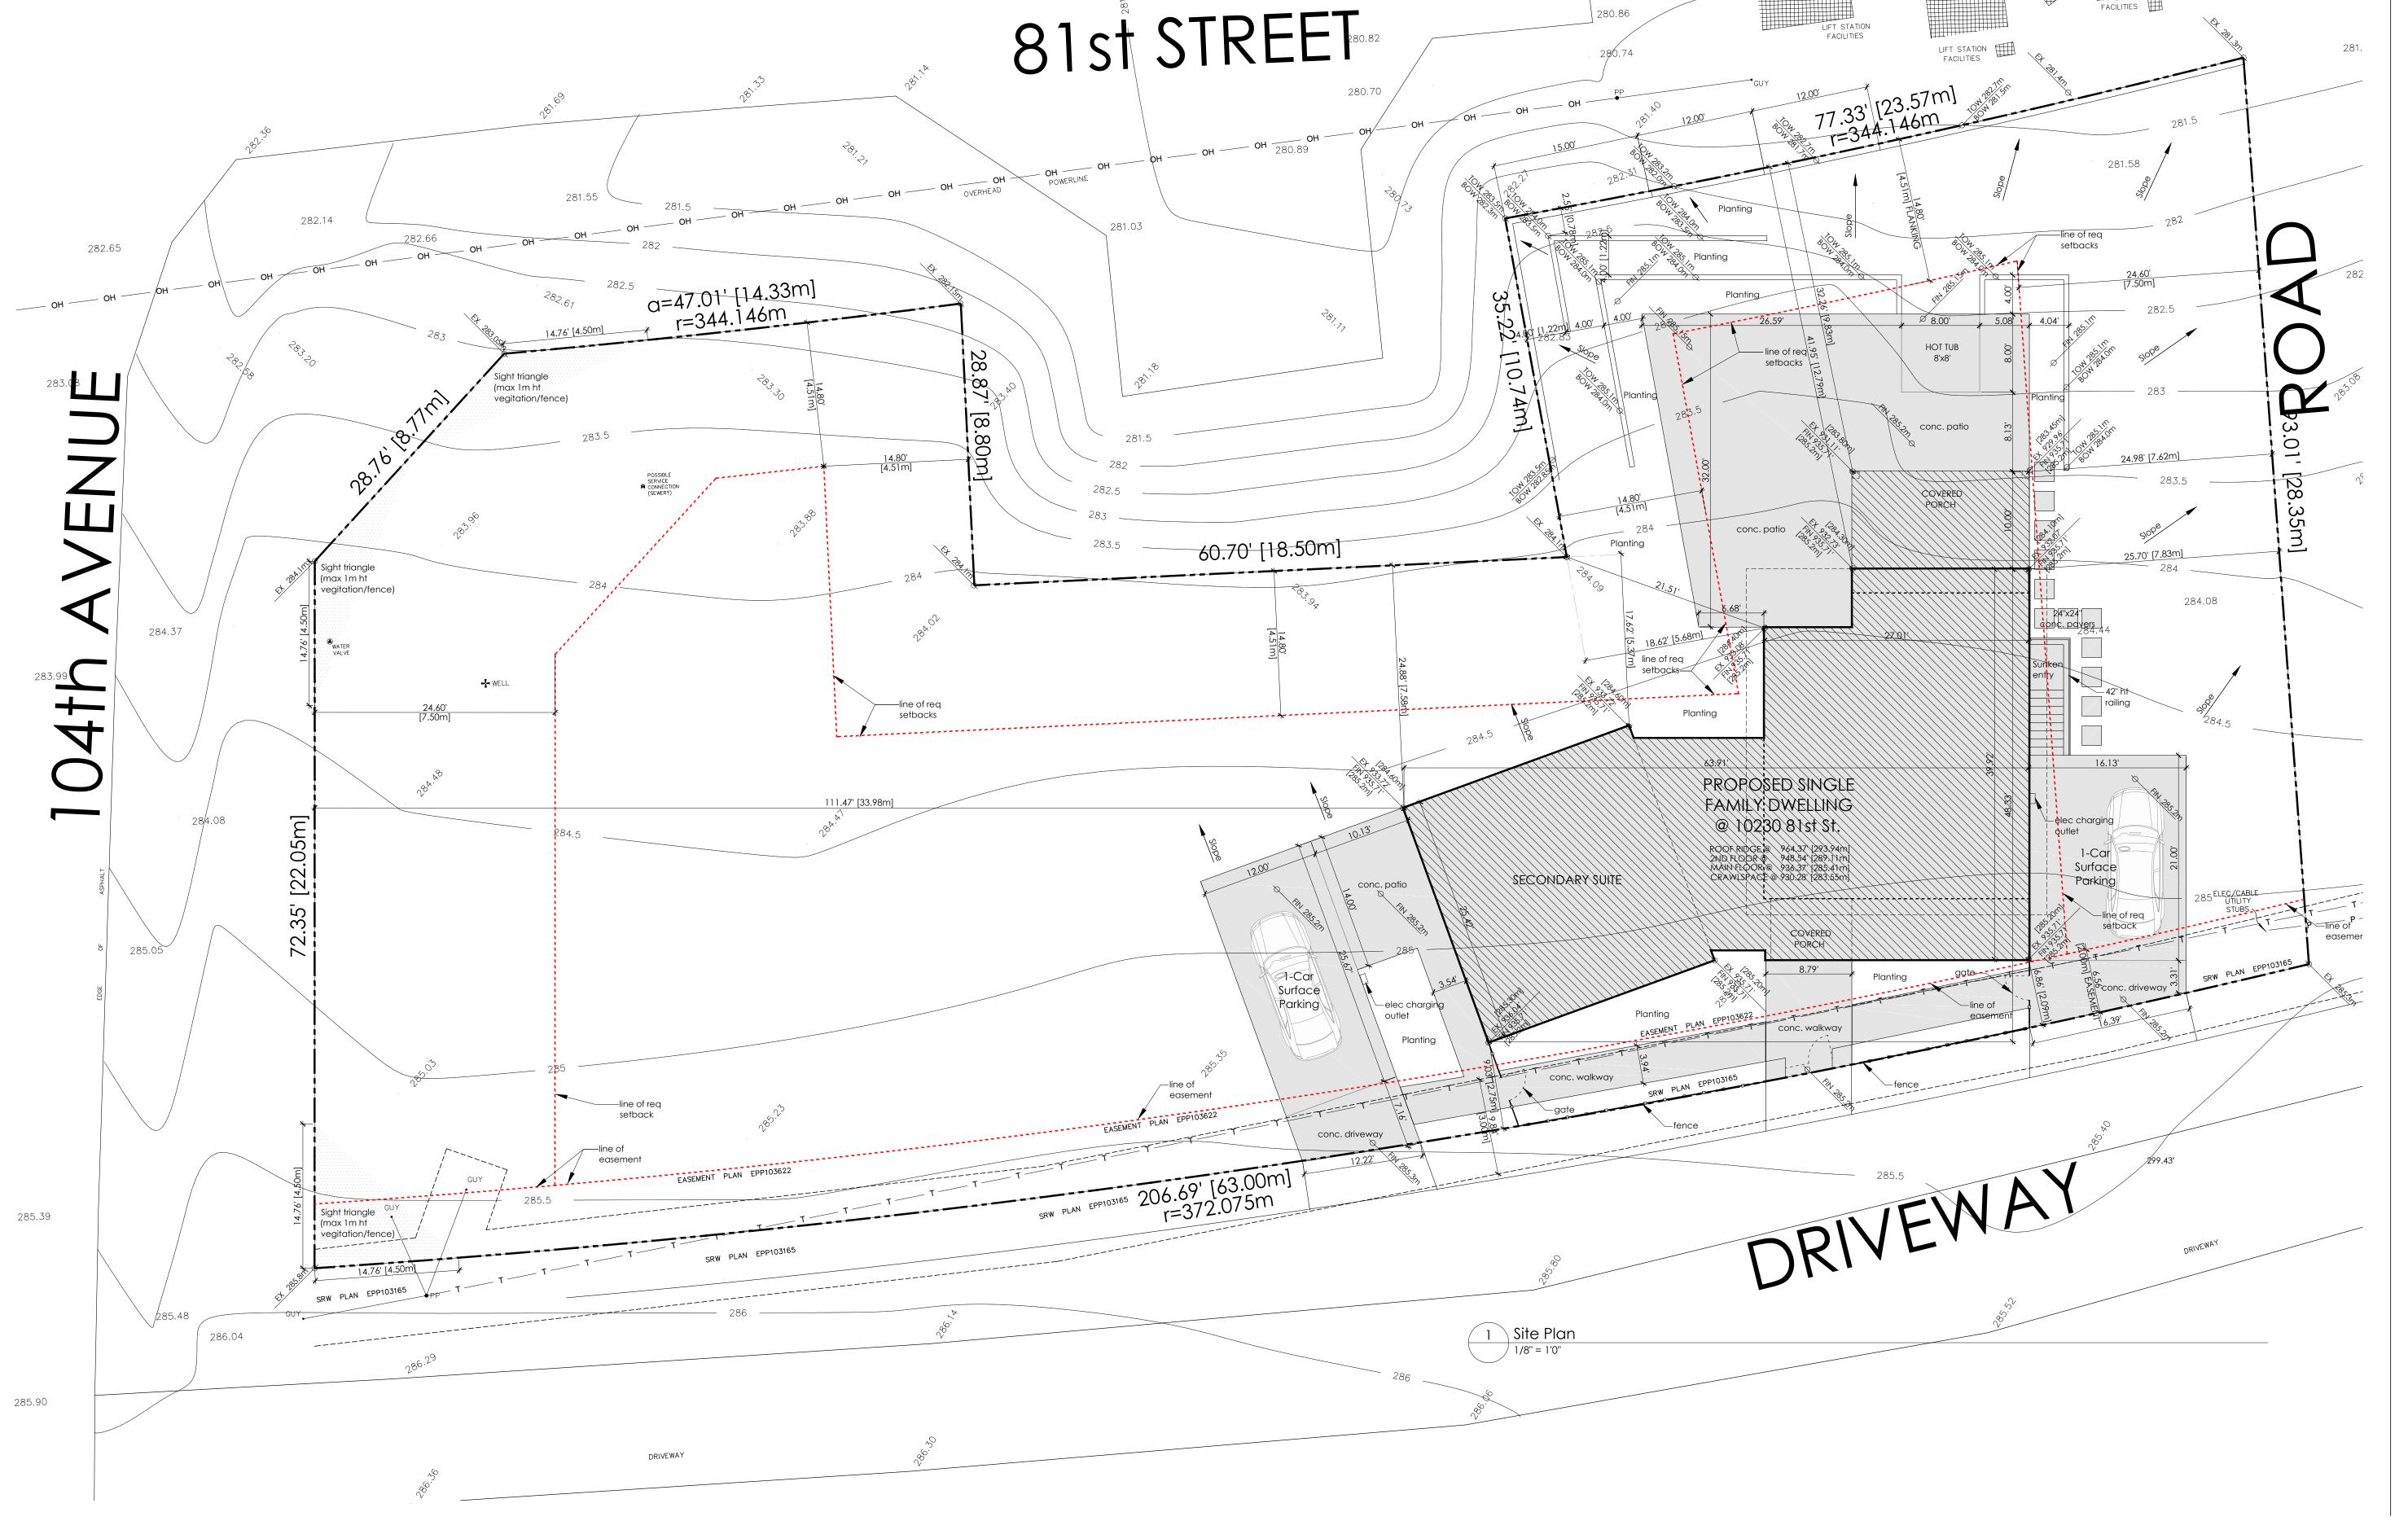
DRAWING

Site Plan


DRAWN BY: MM SHEET:

CHECKED BY: KA

SCALE: 1/8"=1'0"





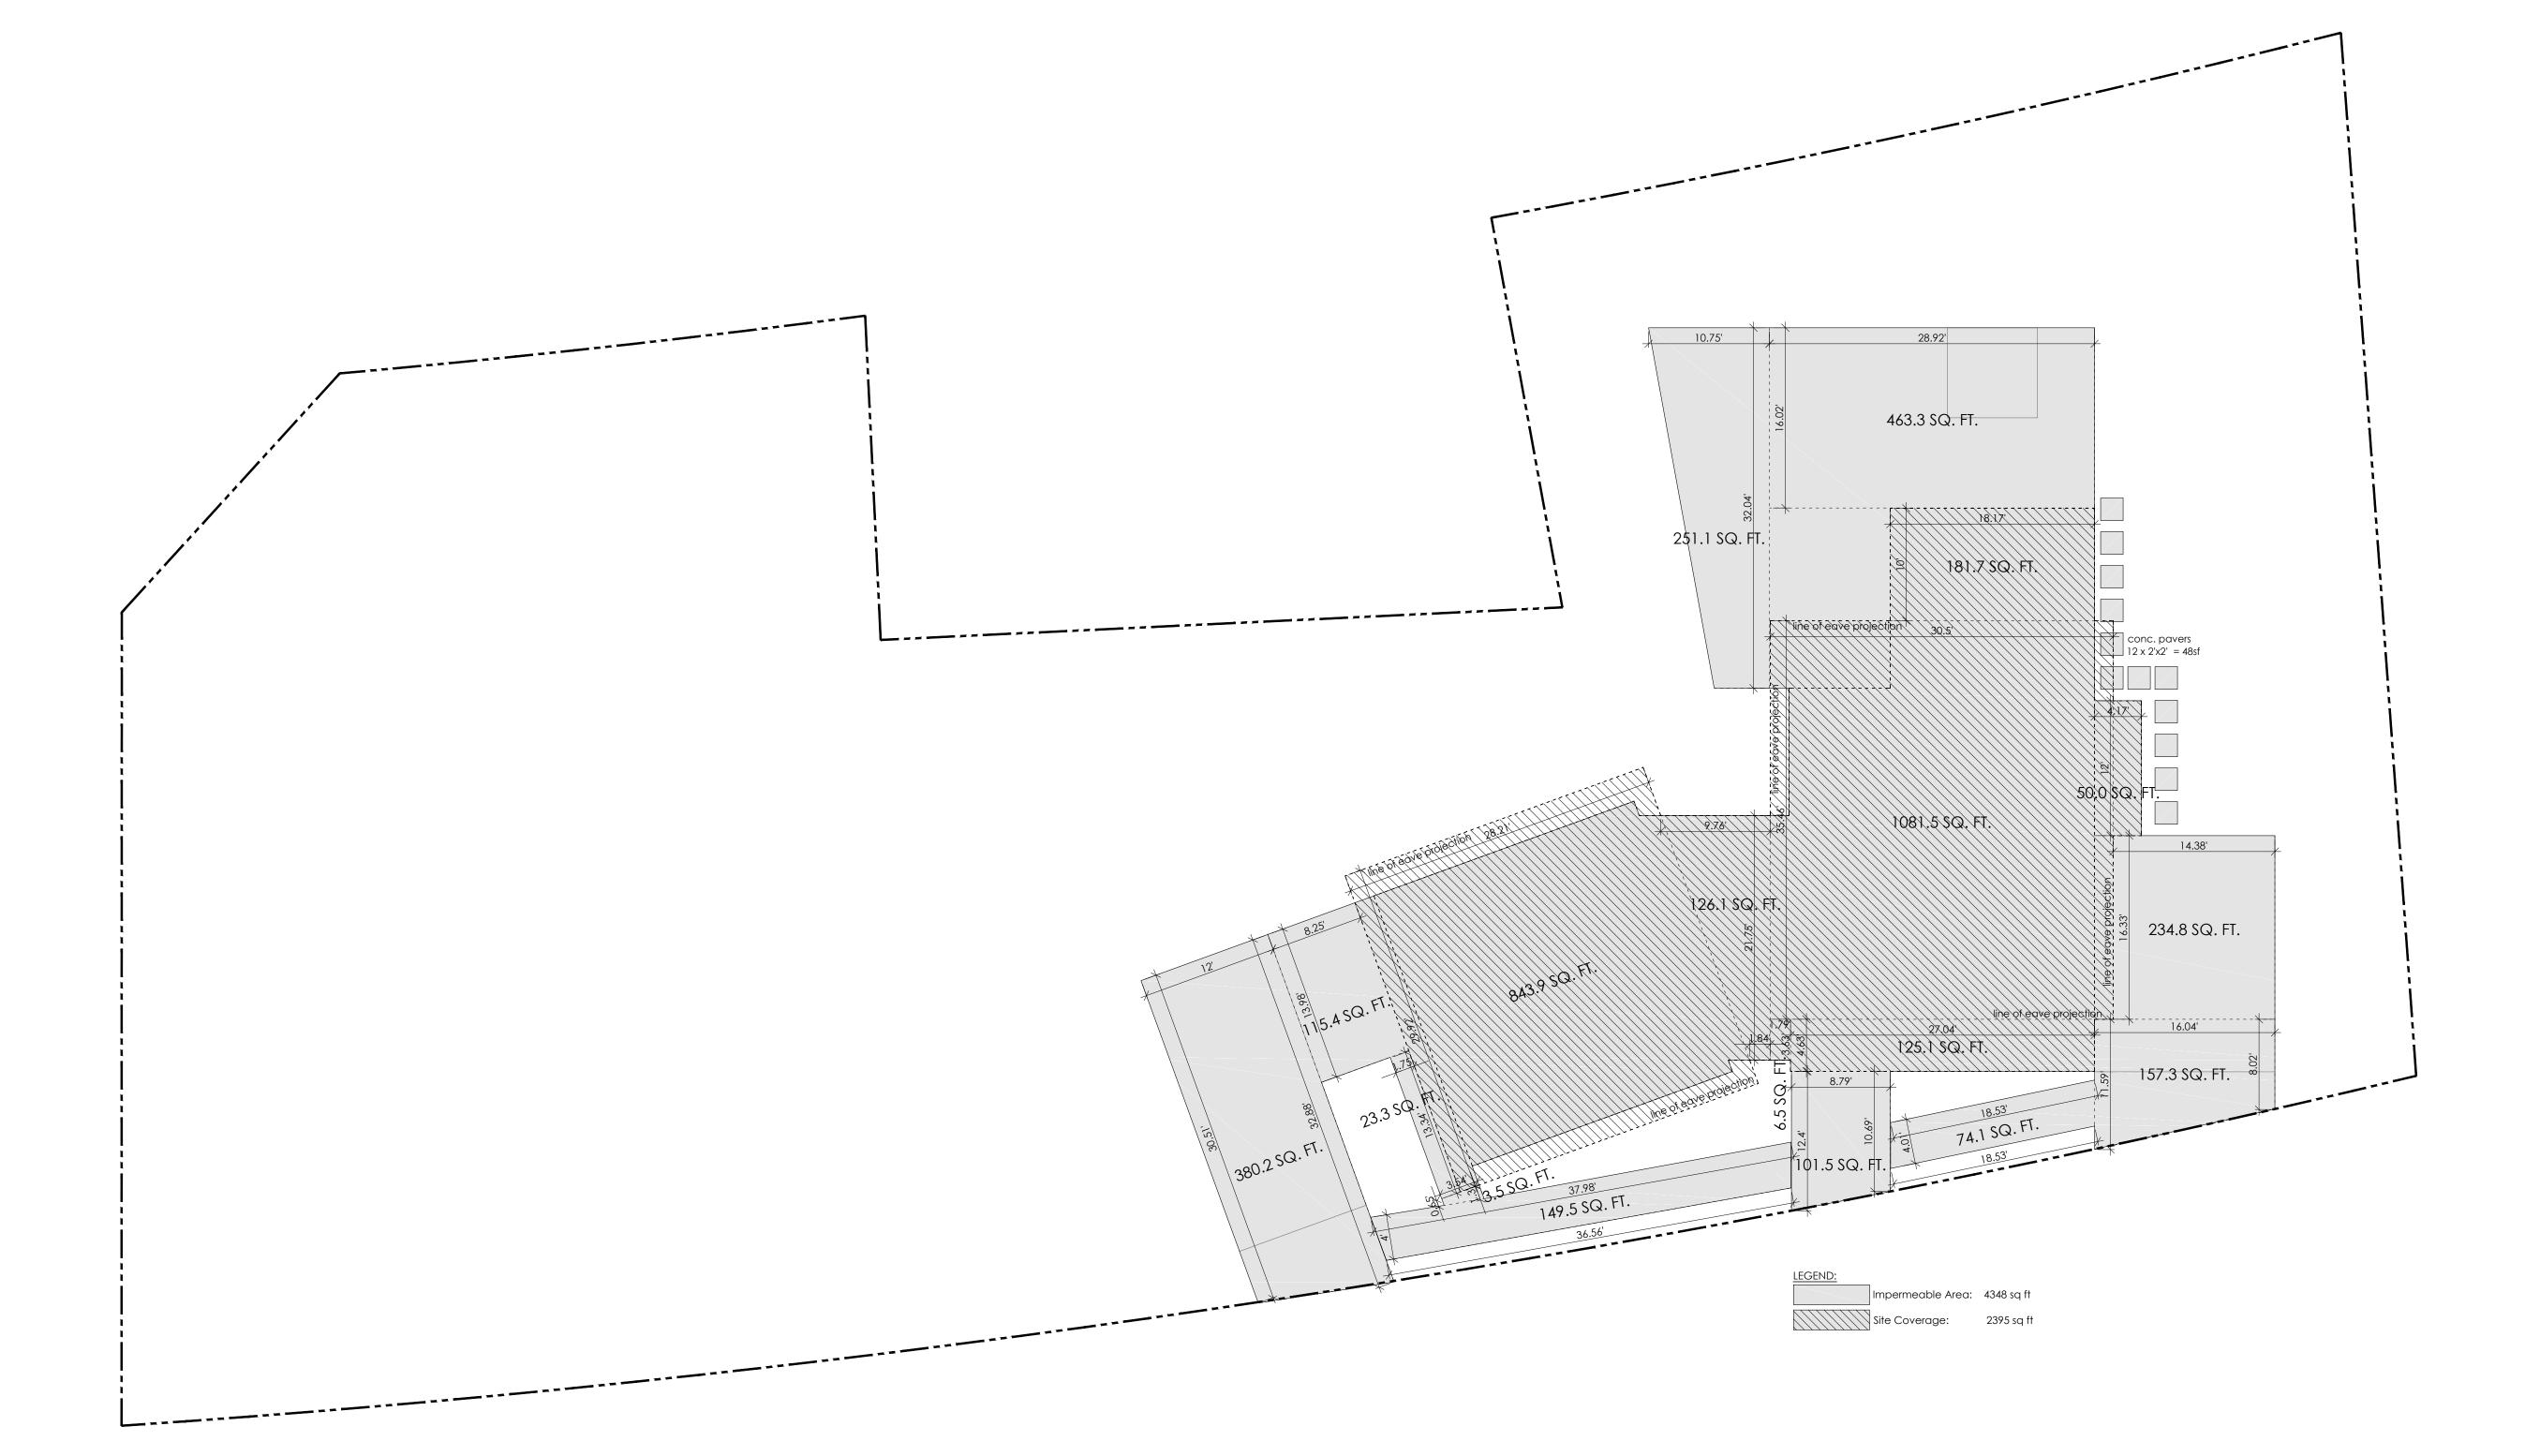

1 Impermeable & Coverage Area Plan



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DRAWING

Impermeable & Coverage Plan

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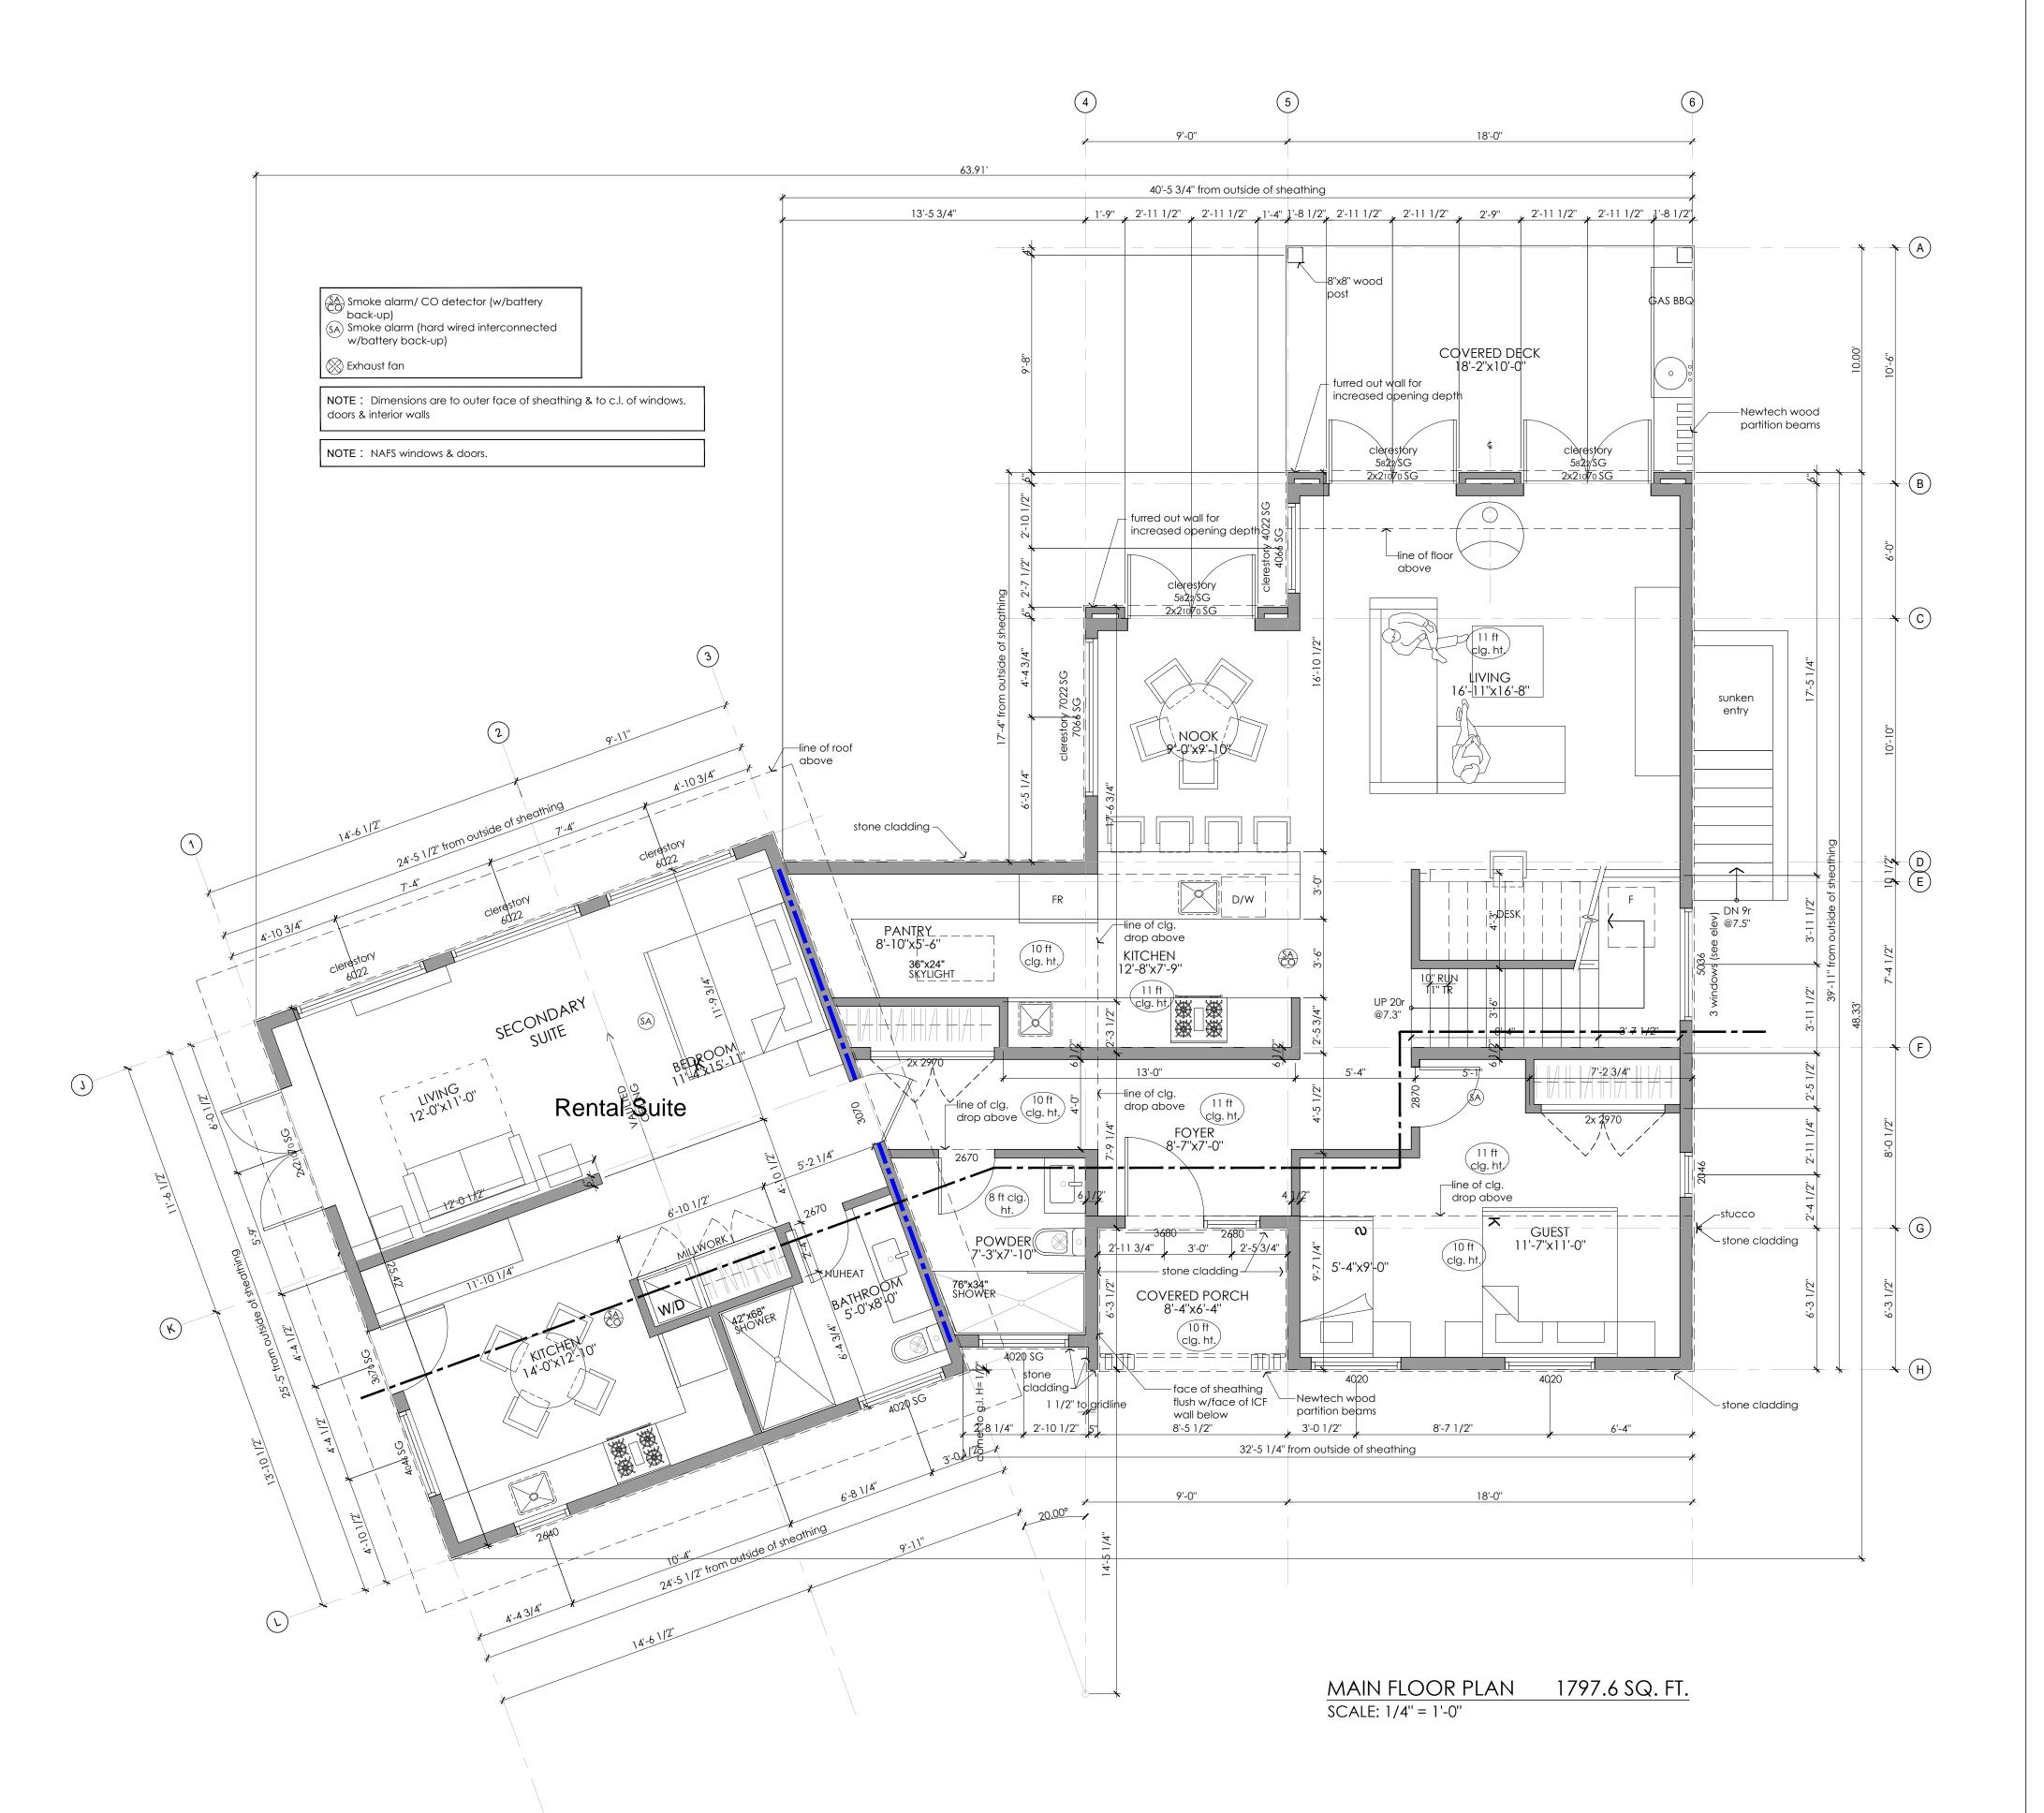
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A0.2







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DRAWING

Main Floor Plan


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SCALE: 1/4"=1'0"

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DRAWING

Upper Floor Plan

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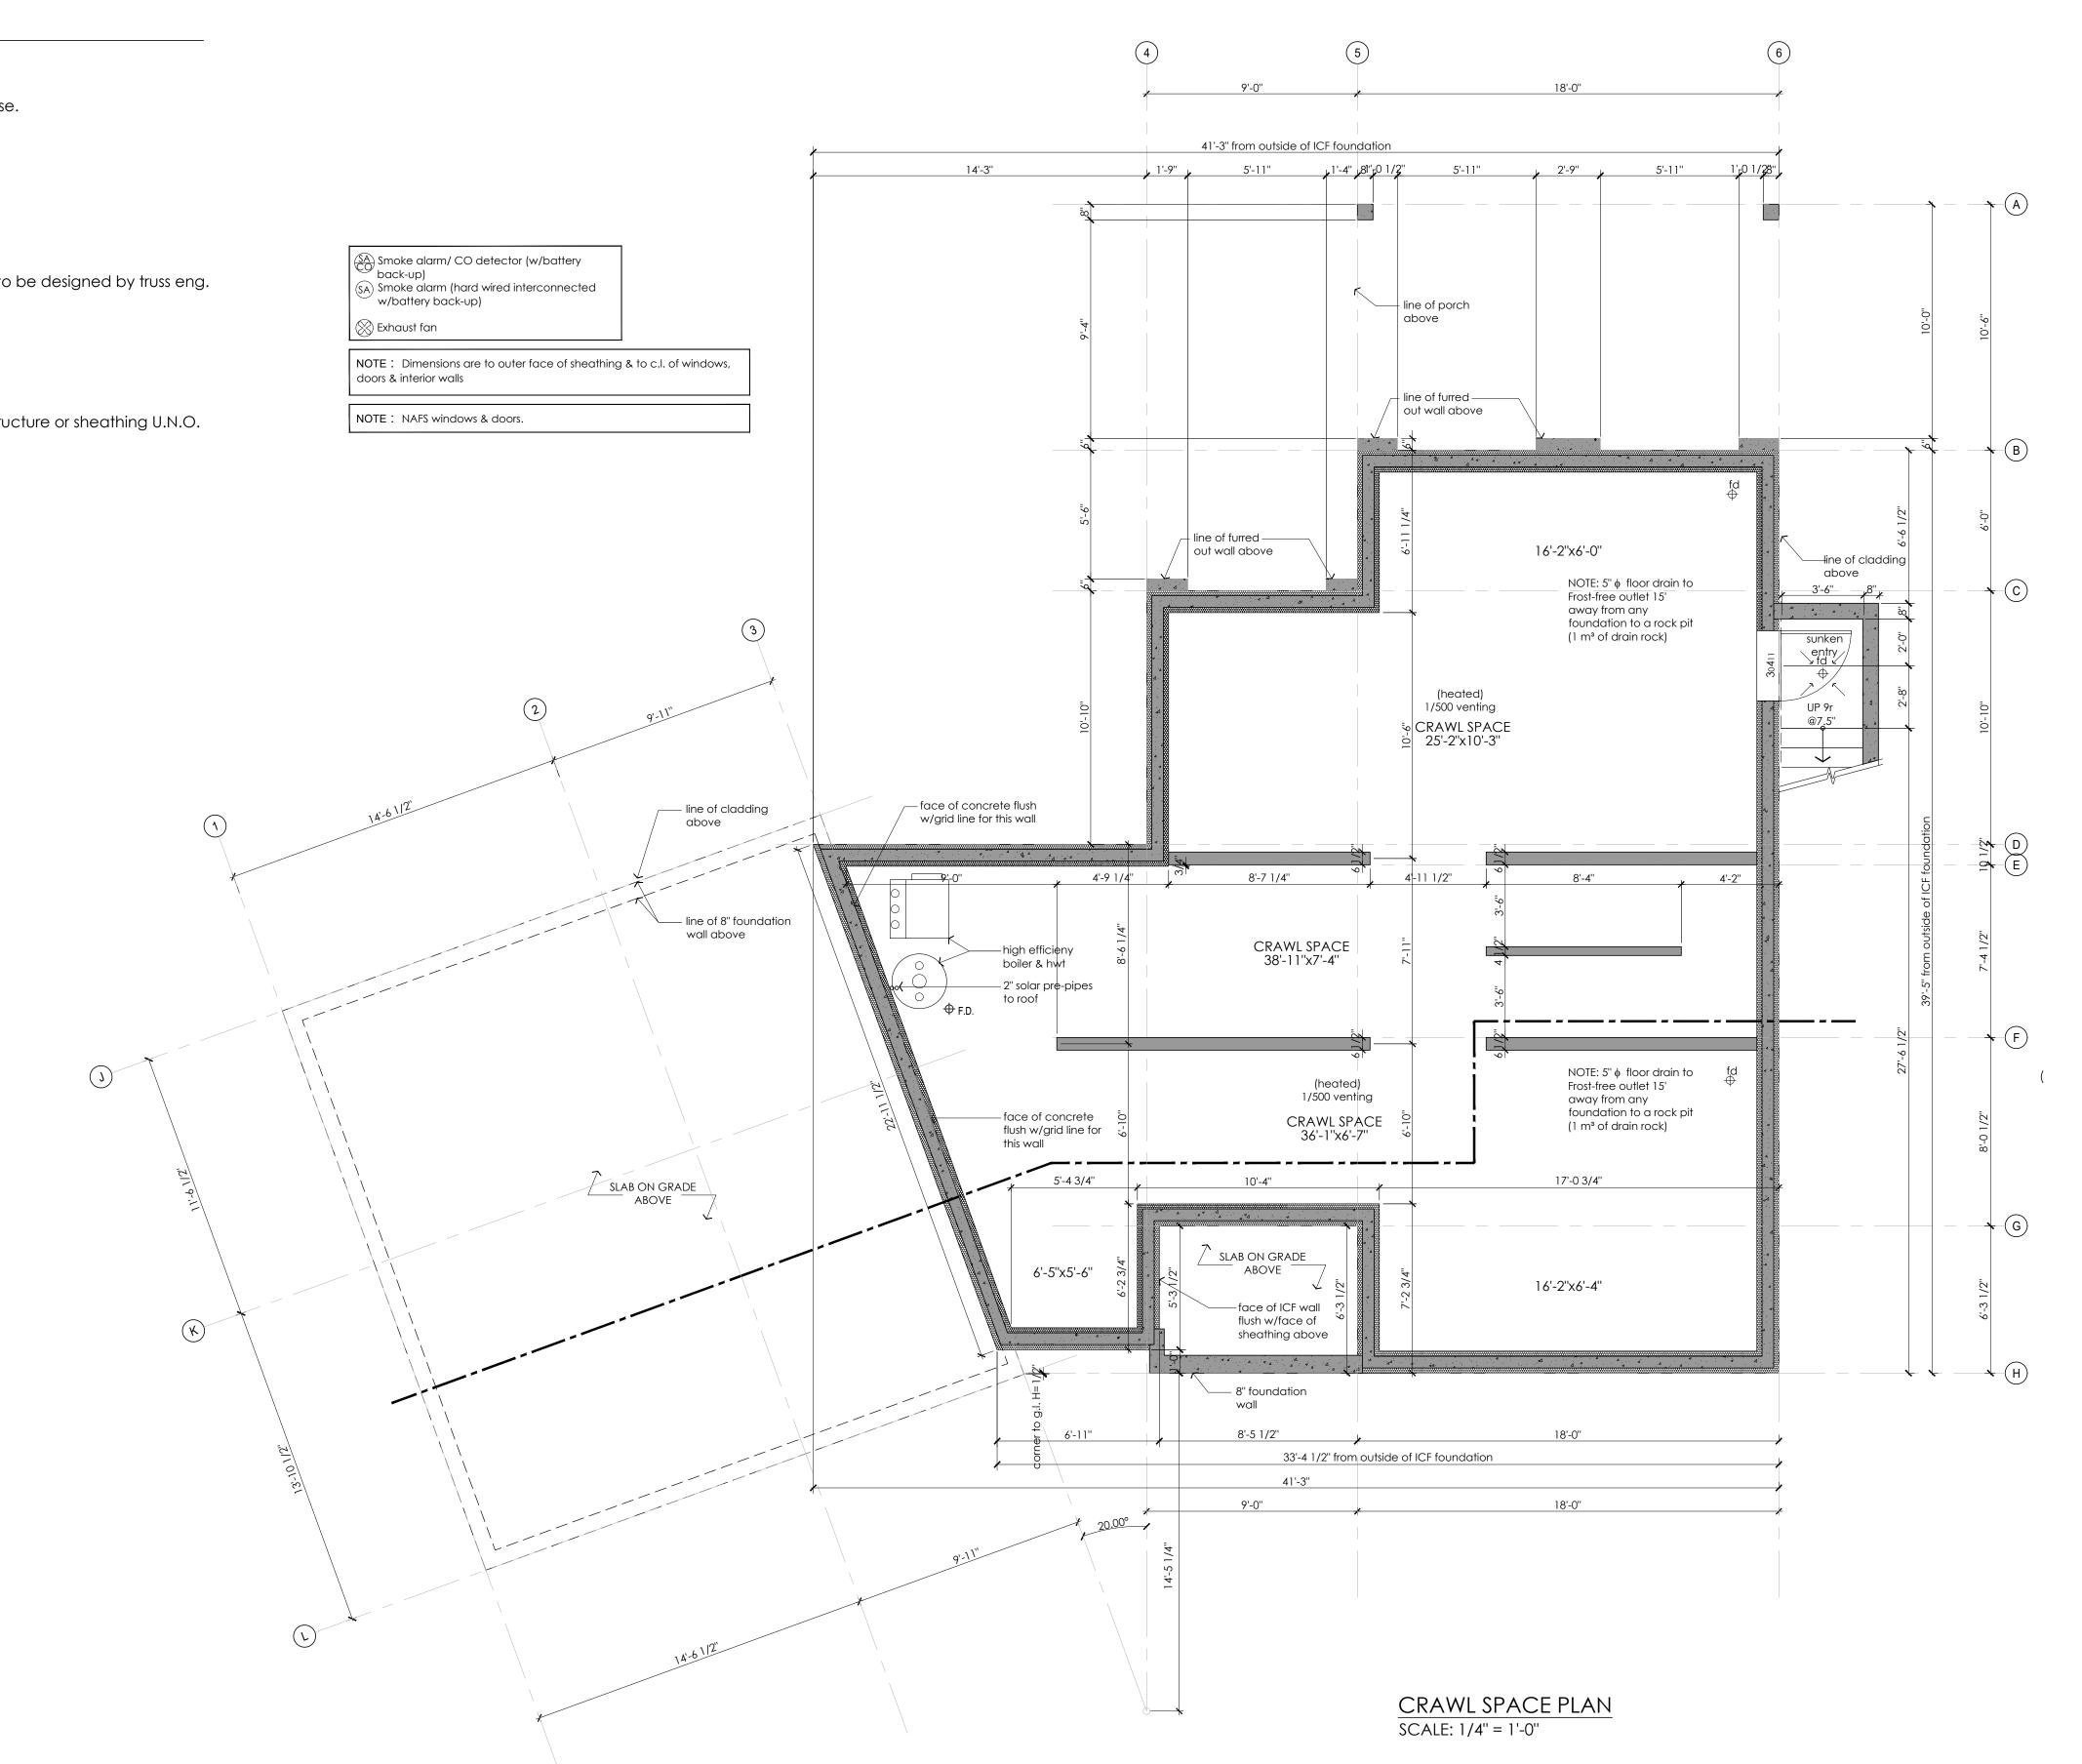
SCALE: 1/4"=1'0"

DATE: 01 MAY 21

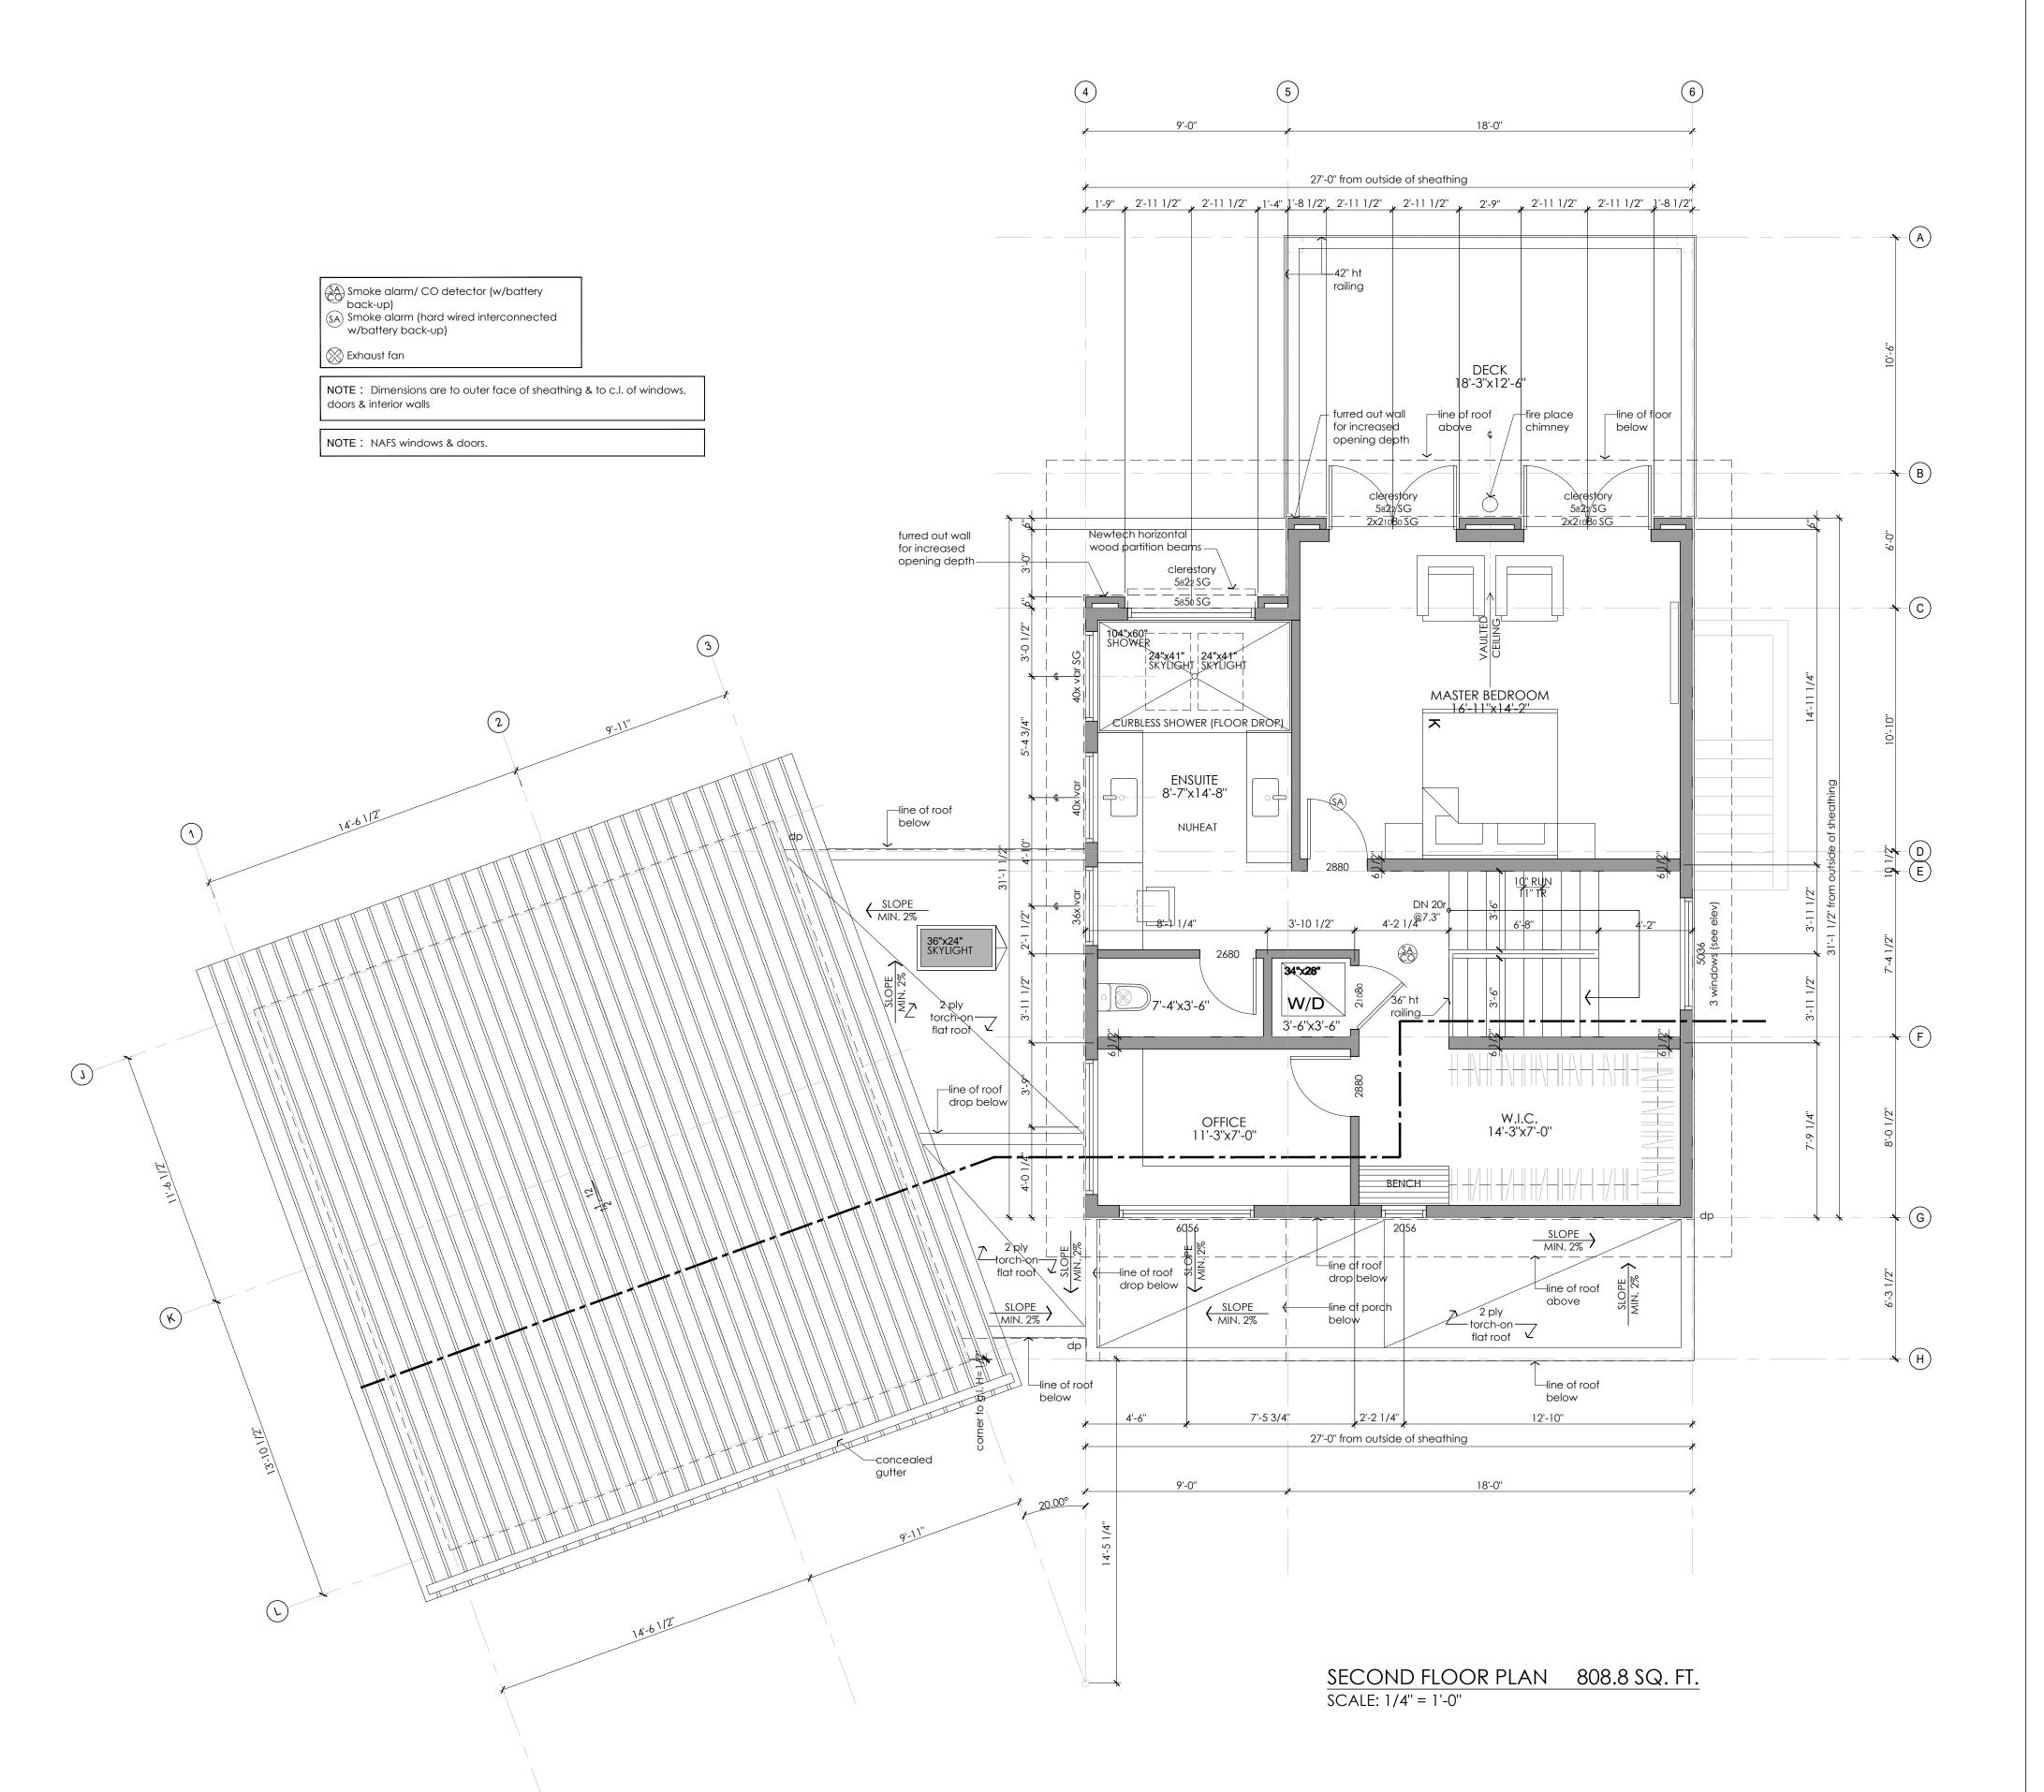

General Notes

- All concrete to be 20 MPa (3000 p.s.i.) @ 28 days.
- All lintels in load bearing walls to be 2-2x10 unless noted otherwise.
- All plates on concrete to be rot treated.
- Flush framed members shall be anchored with joist hangers.
- Flash all unprotected openings & changes in exterior materials.
- Fireplaces to be installed to manufacturer's specifications.
- Roof trusses, floor joists, lintels, beams and posts below pt loads to be designed by truss eng.
- All grades are approximate only.
- All structural lumber to be #1&2 SPF or better U.N.O.
- Do not use finger jointed studs under beams, lintels, or girders.
- All dimensions to floor, wall, or roof assemblies are taken from structure or sheathing U.N.O.





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DRAWING

Crawl Space Plan


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SCALE: 1/4"=1'0"

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DRAWING

Roof Plan

DRAWN BY: MM

CHECKED BY: K

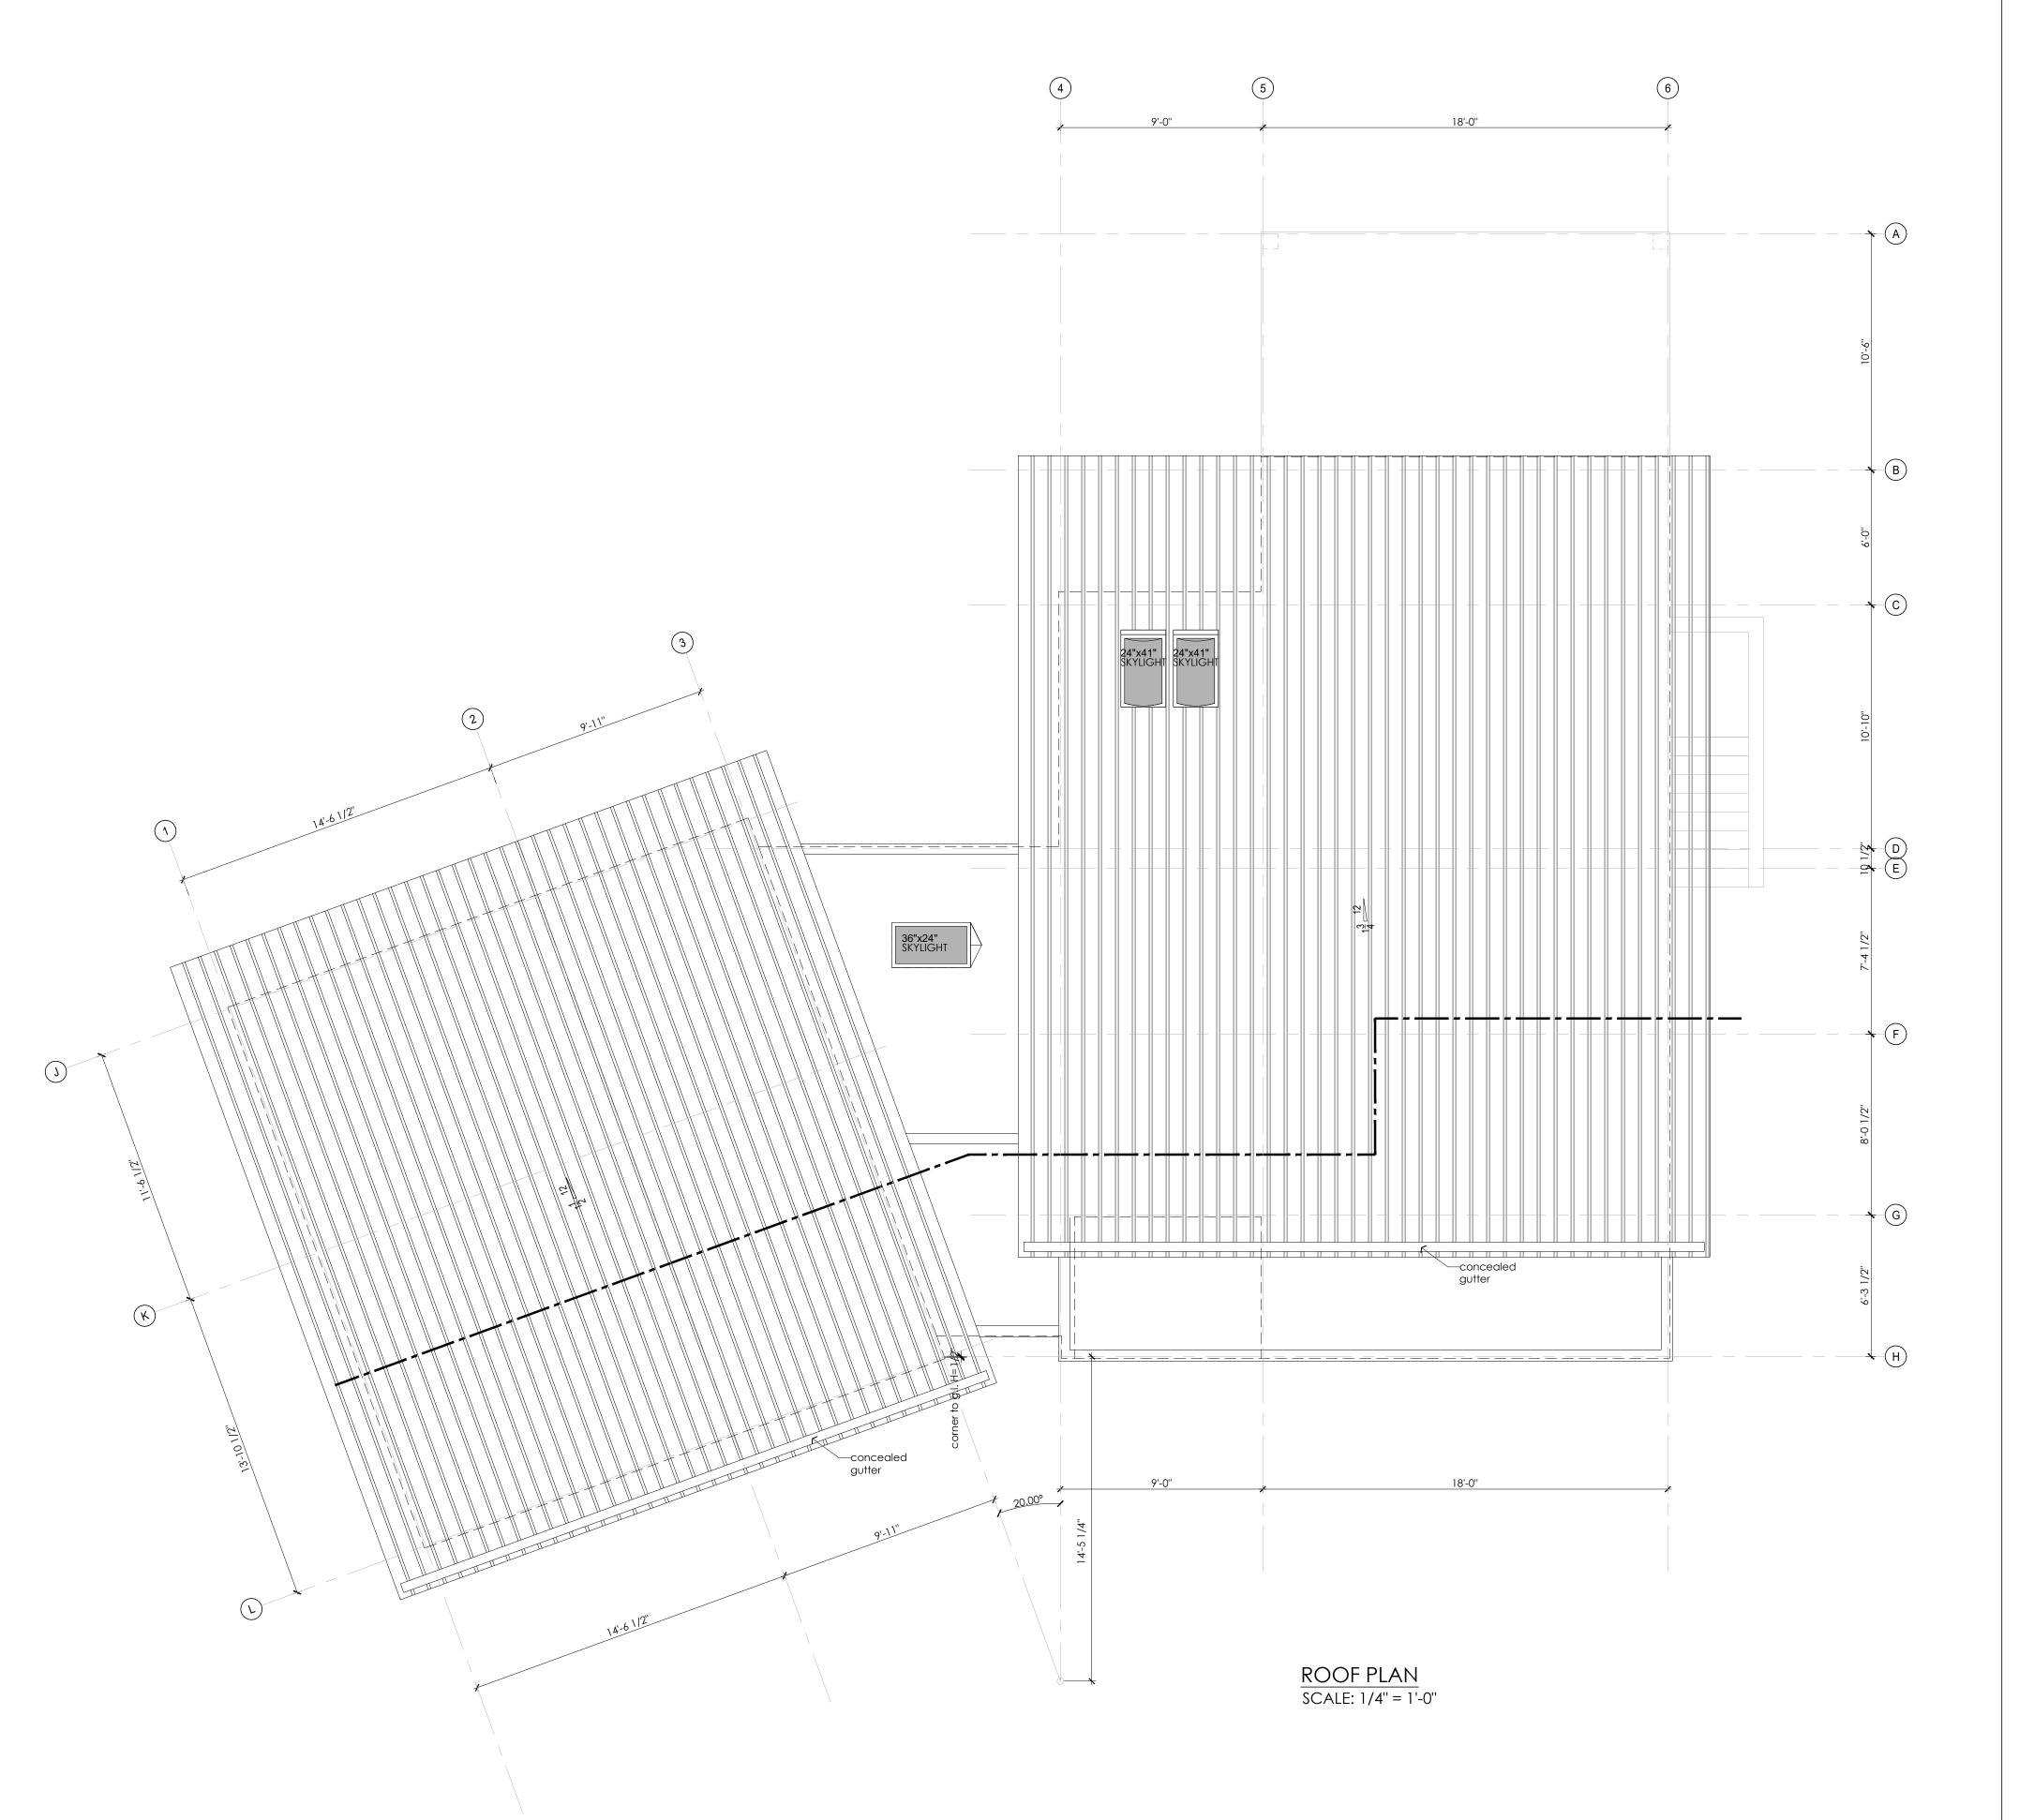1/4"=1'0" 01 MAY 21







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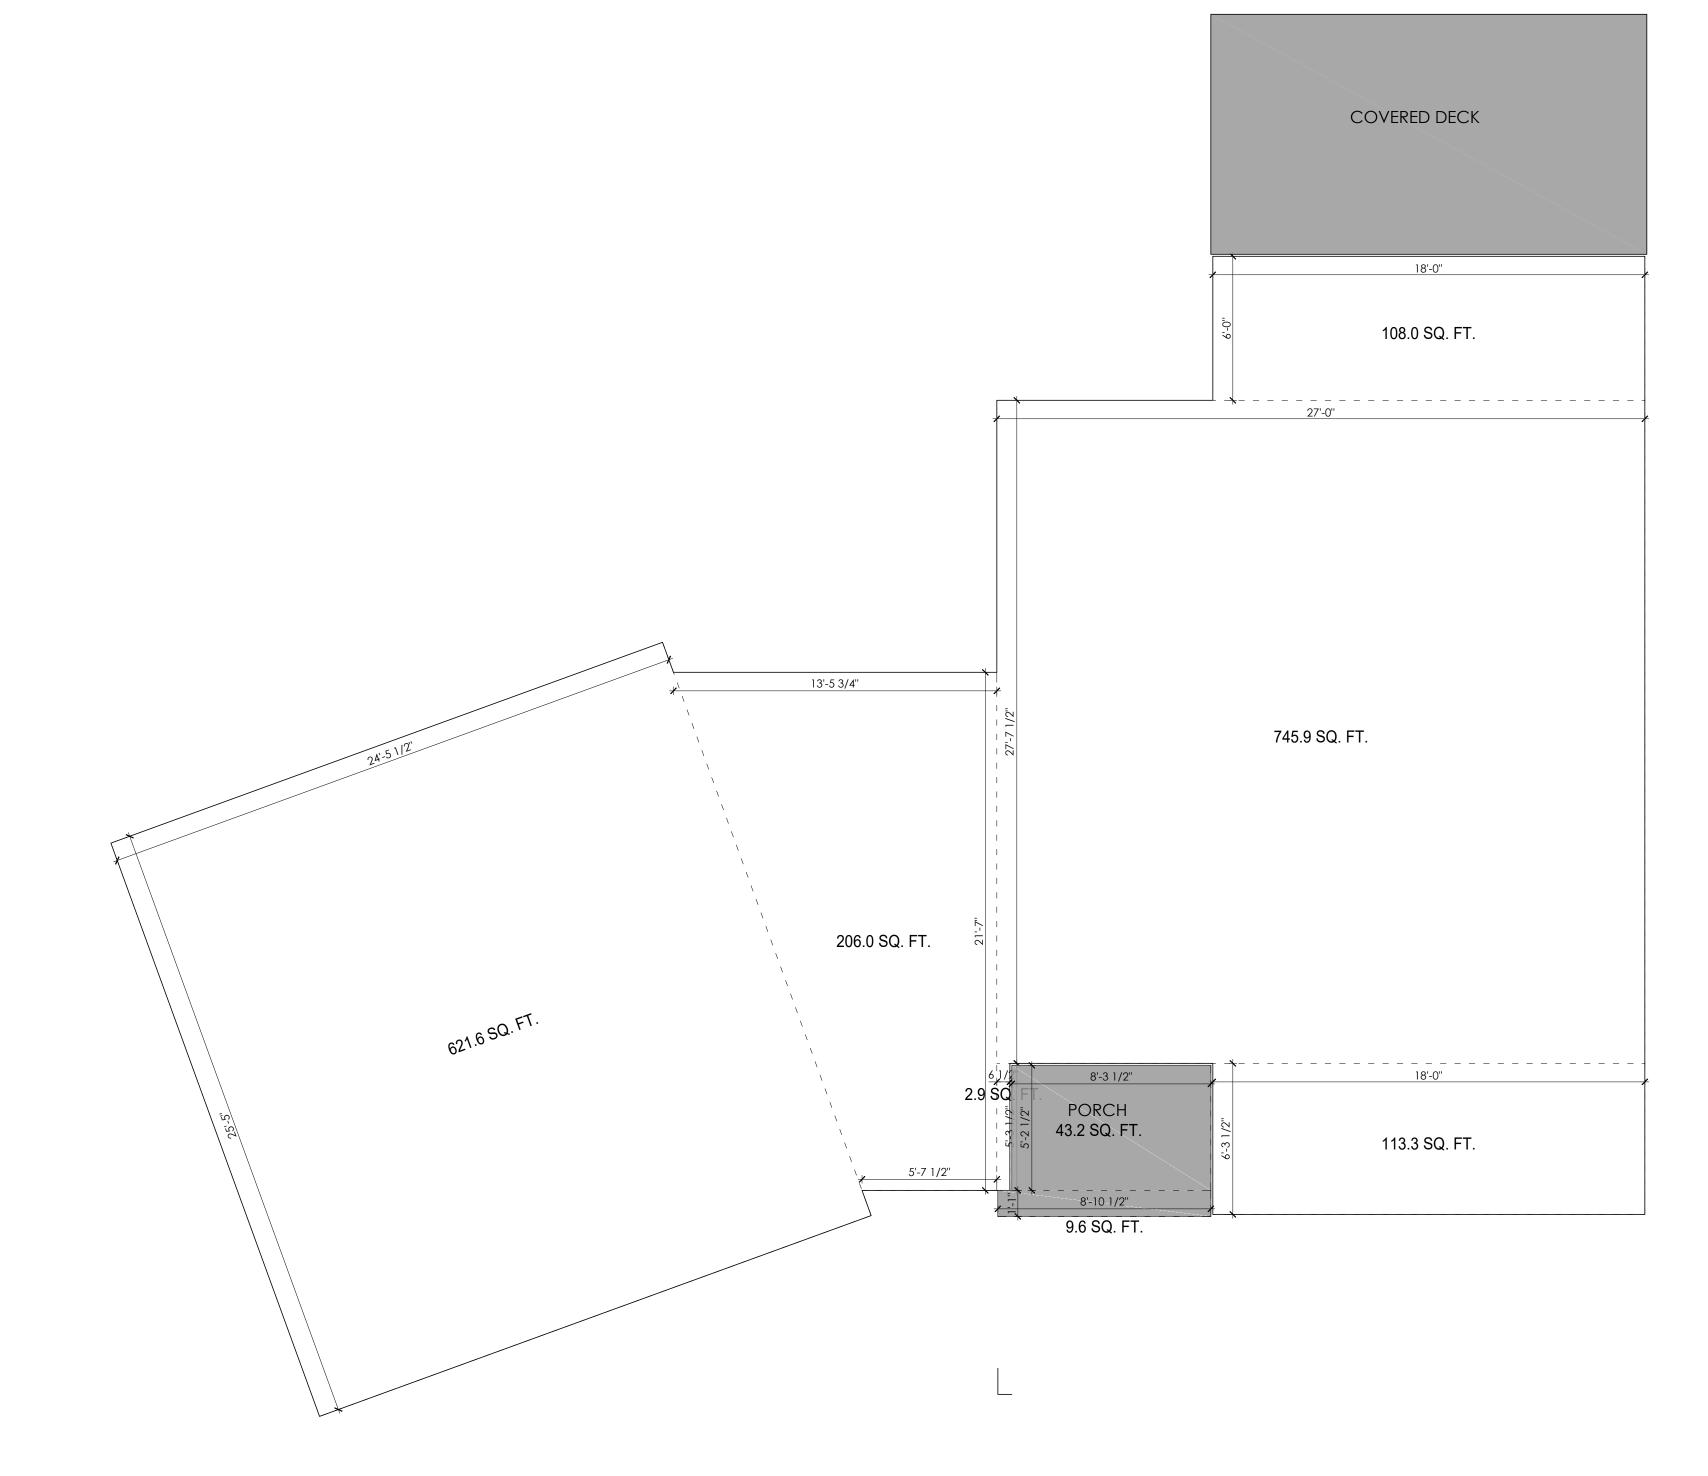
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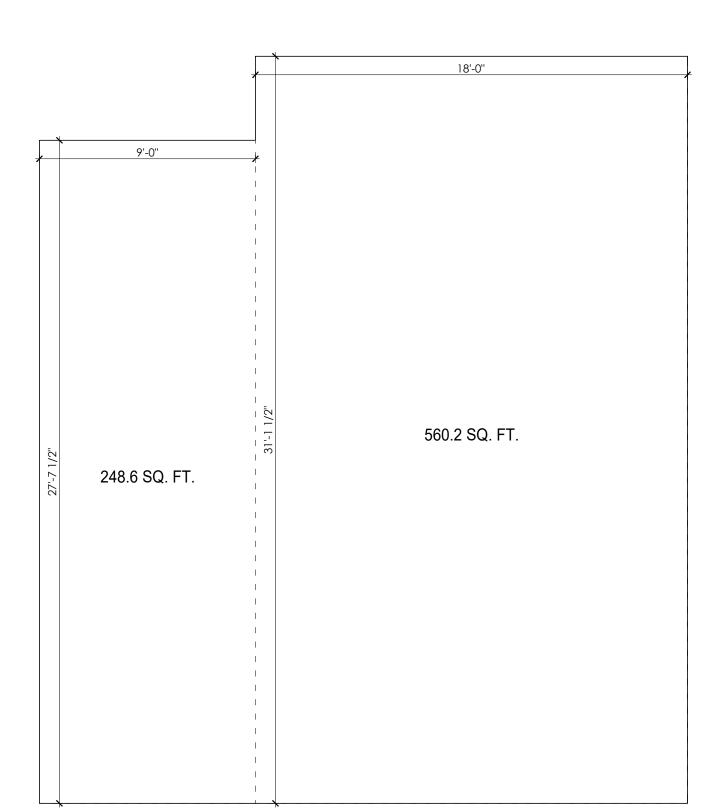
DRAWING

Area Overlay Plans

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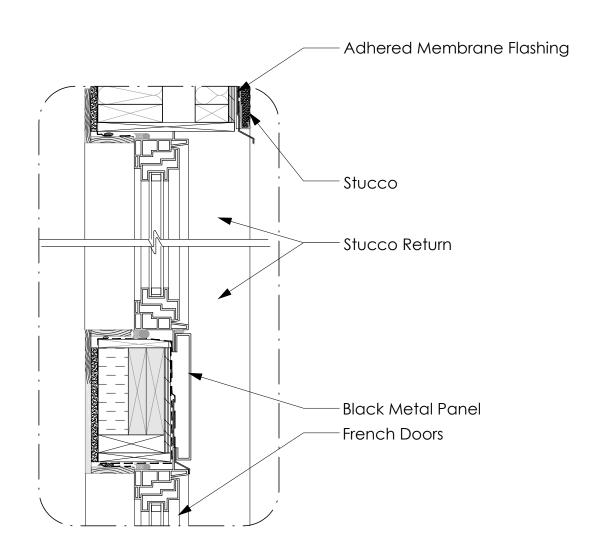
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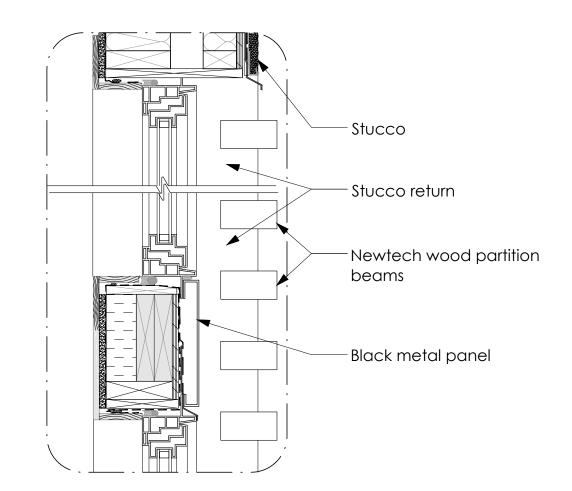
MAIN FLOOR PLAN 1797.6 SQ. FT. SCALE: 1/4" = 1'-0"

SECOND FLOOR PLAN 808.8 SQ. FT. SCALE: 1/4" = 1'-0"





Recessed Doors Detail

A2.1 1 1/2" = 1'-0"



2 Master Ensuite Window Det. A2.1 1 1/2" = 1'-0"

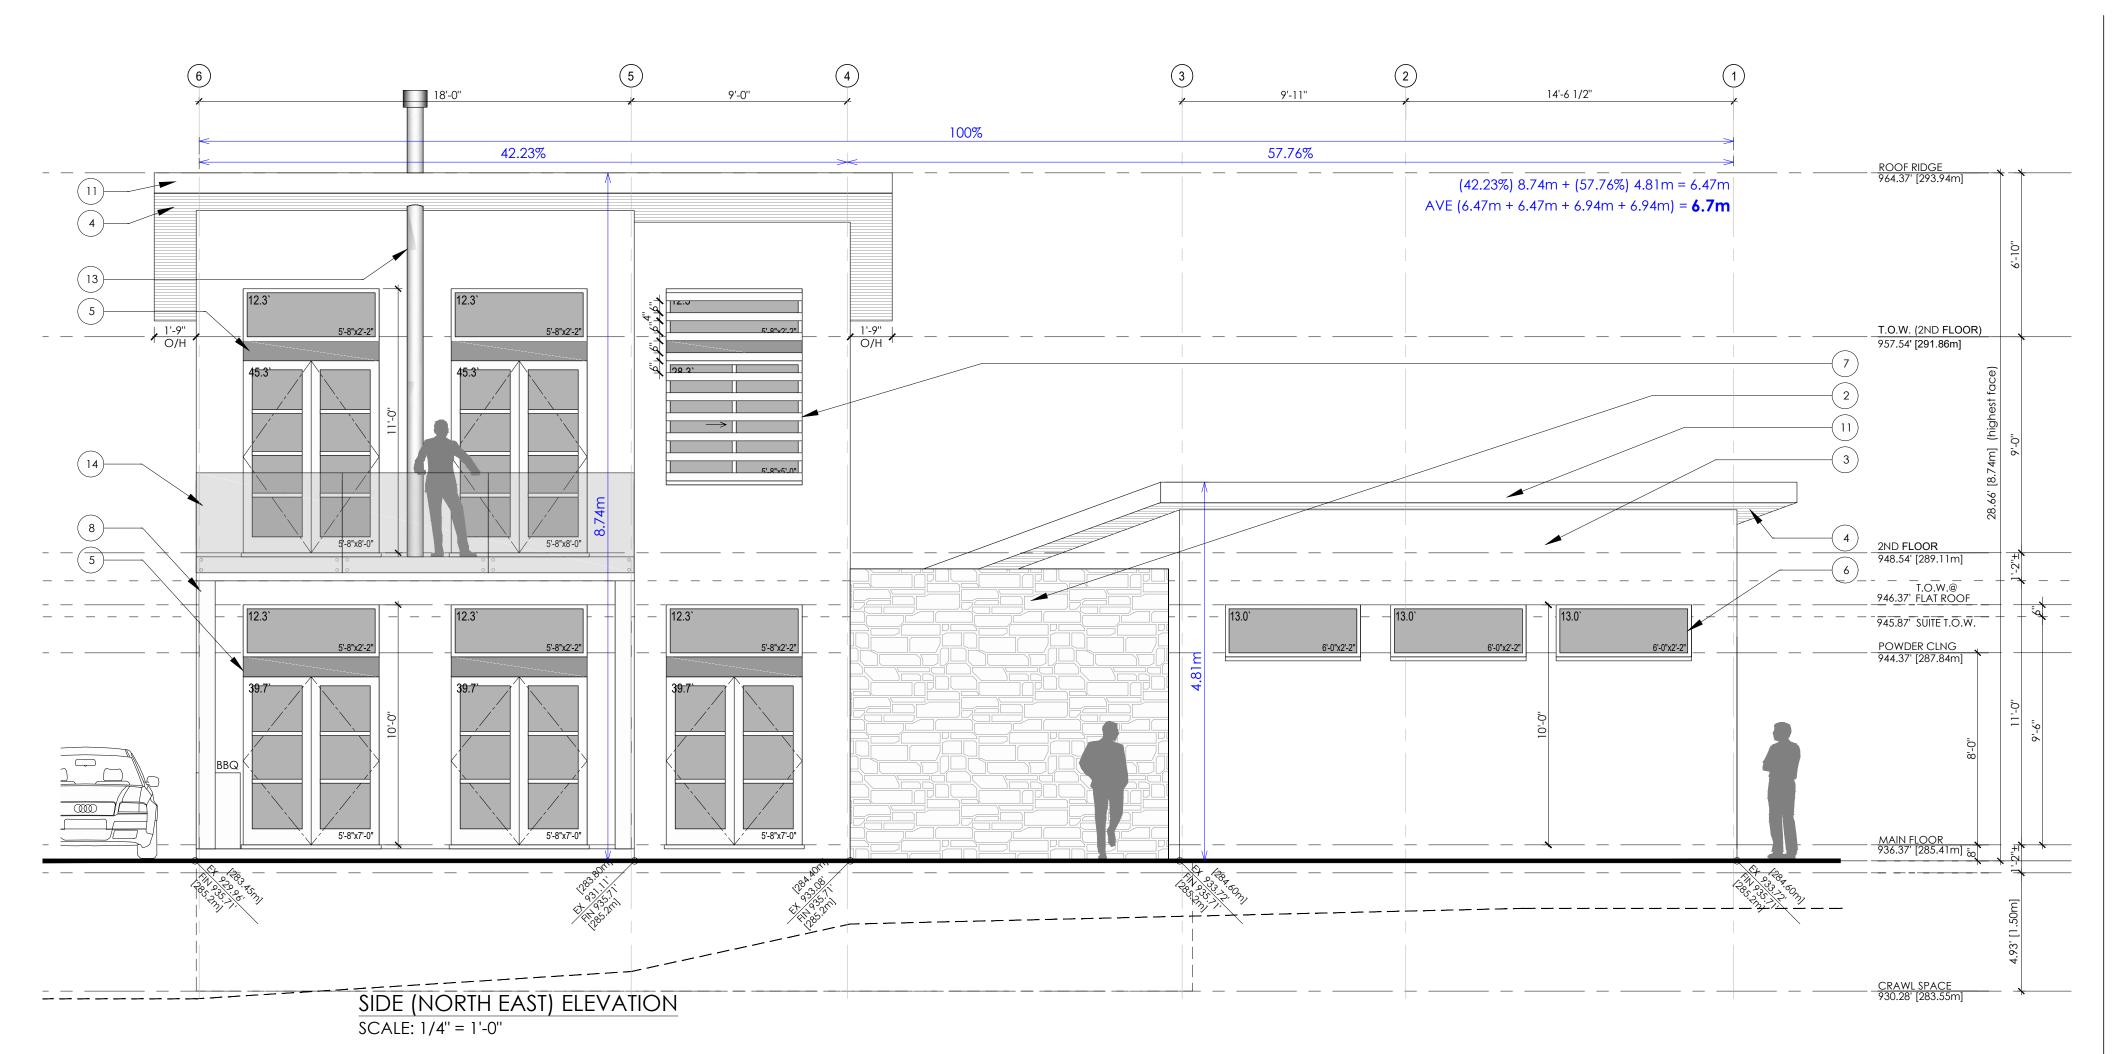

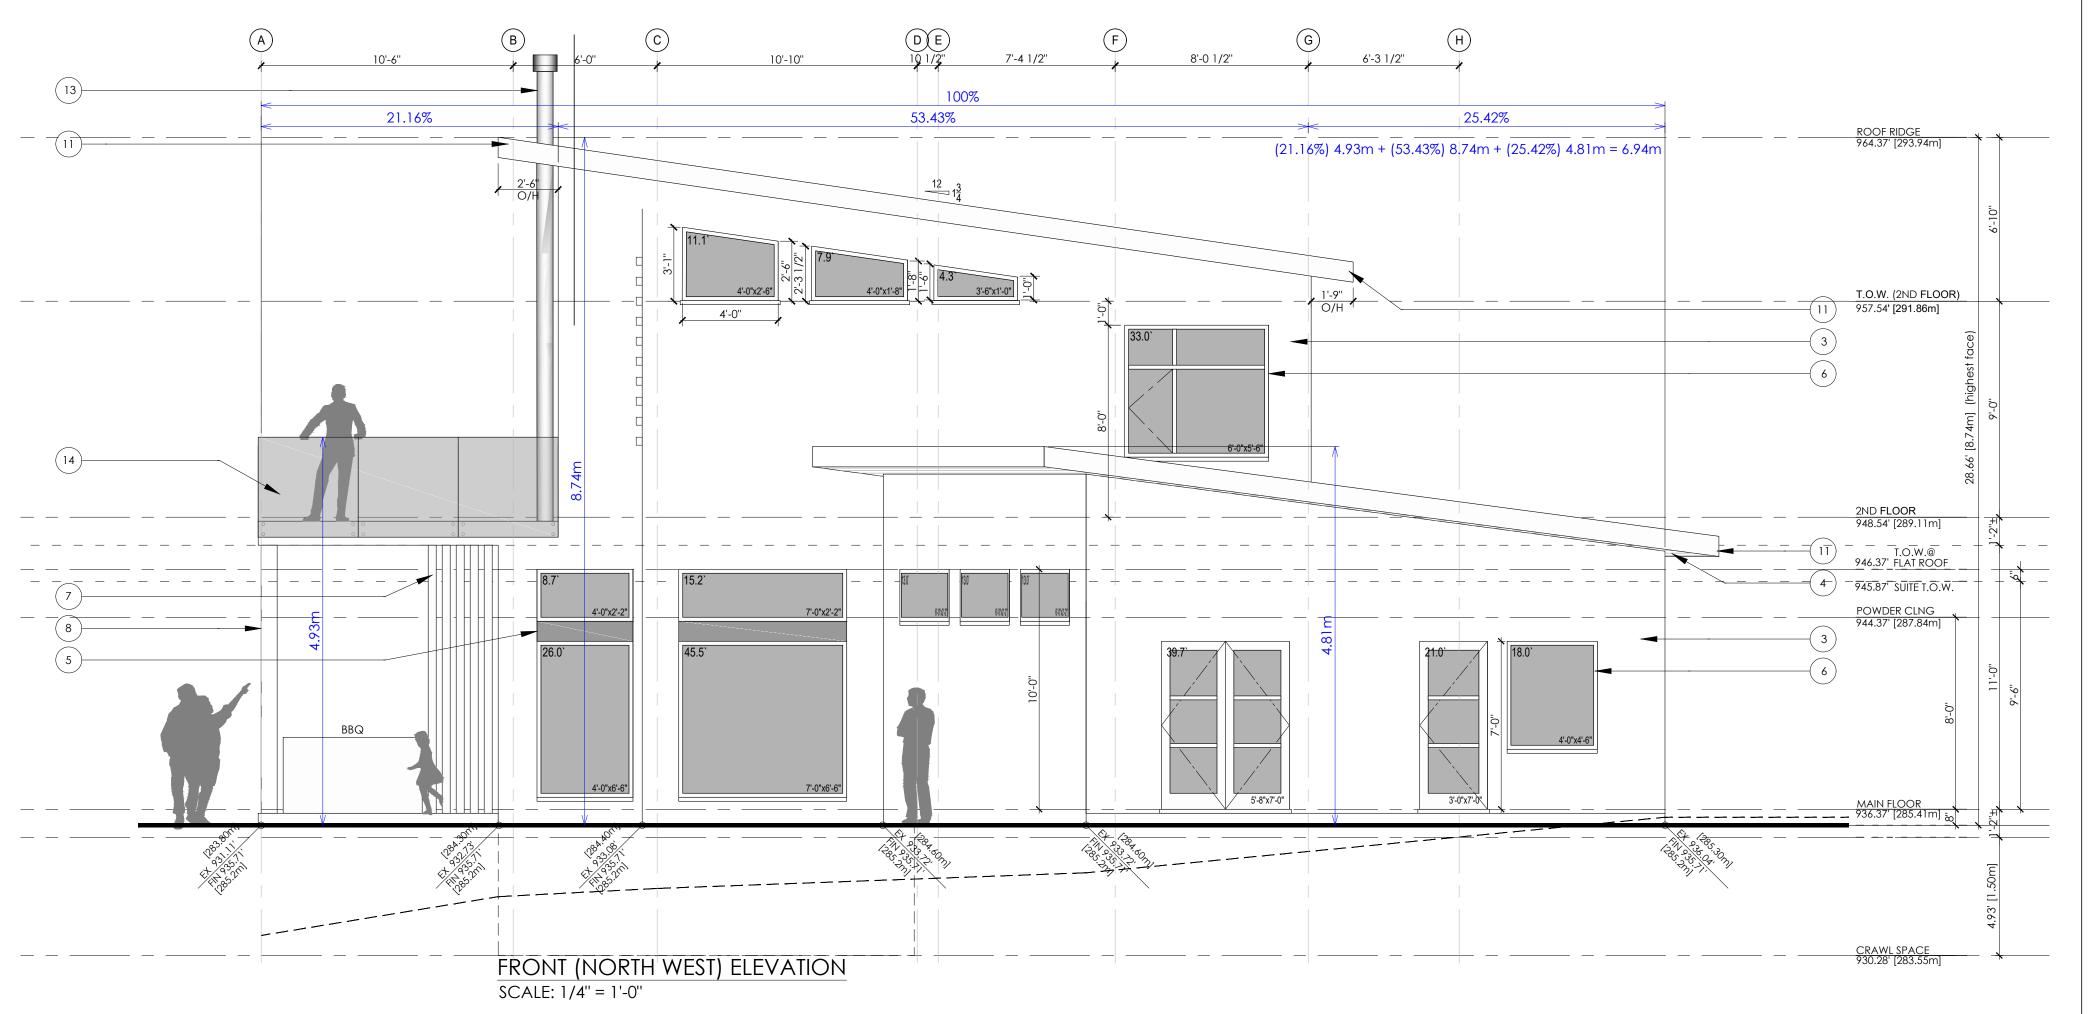



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NOTES

Exterior Finishes

- Standing seam metal roofing (typ.)
- 2. Cultured stone veneer cladding
- 3. Smooth face stucco cladding
- 4. Wood grain look aluminum soffit
- 5. Black metal panel
- 7. Newtech wood partition beams, colour: brazilian ipe
- 8. Porch post
- 9. Cast concrete window sill within Stone Wall

6. Black Vinyl windows (NAFS Compliant)

- 10. Integrated gutter
- 11. 2x10 Bargeboard
- 12. Stained solid wood entry door
- 13. Metal fireplace chimney (min 3' above highest ridge)
- 14. Tempered glass railing
- 15. Black metal railing


DRAWING

North East & North West Elevations

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SCALE: 1/4"=1'0"



REAR (SOUTH EAST) ELEVATION
SCALE: 1/4" = 1'-0"

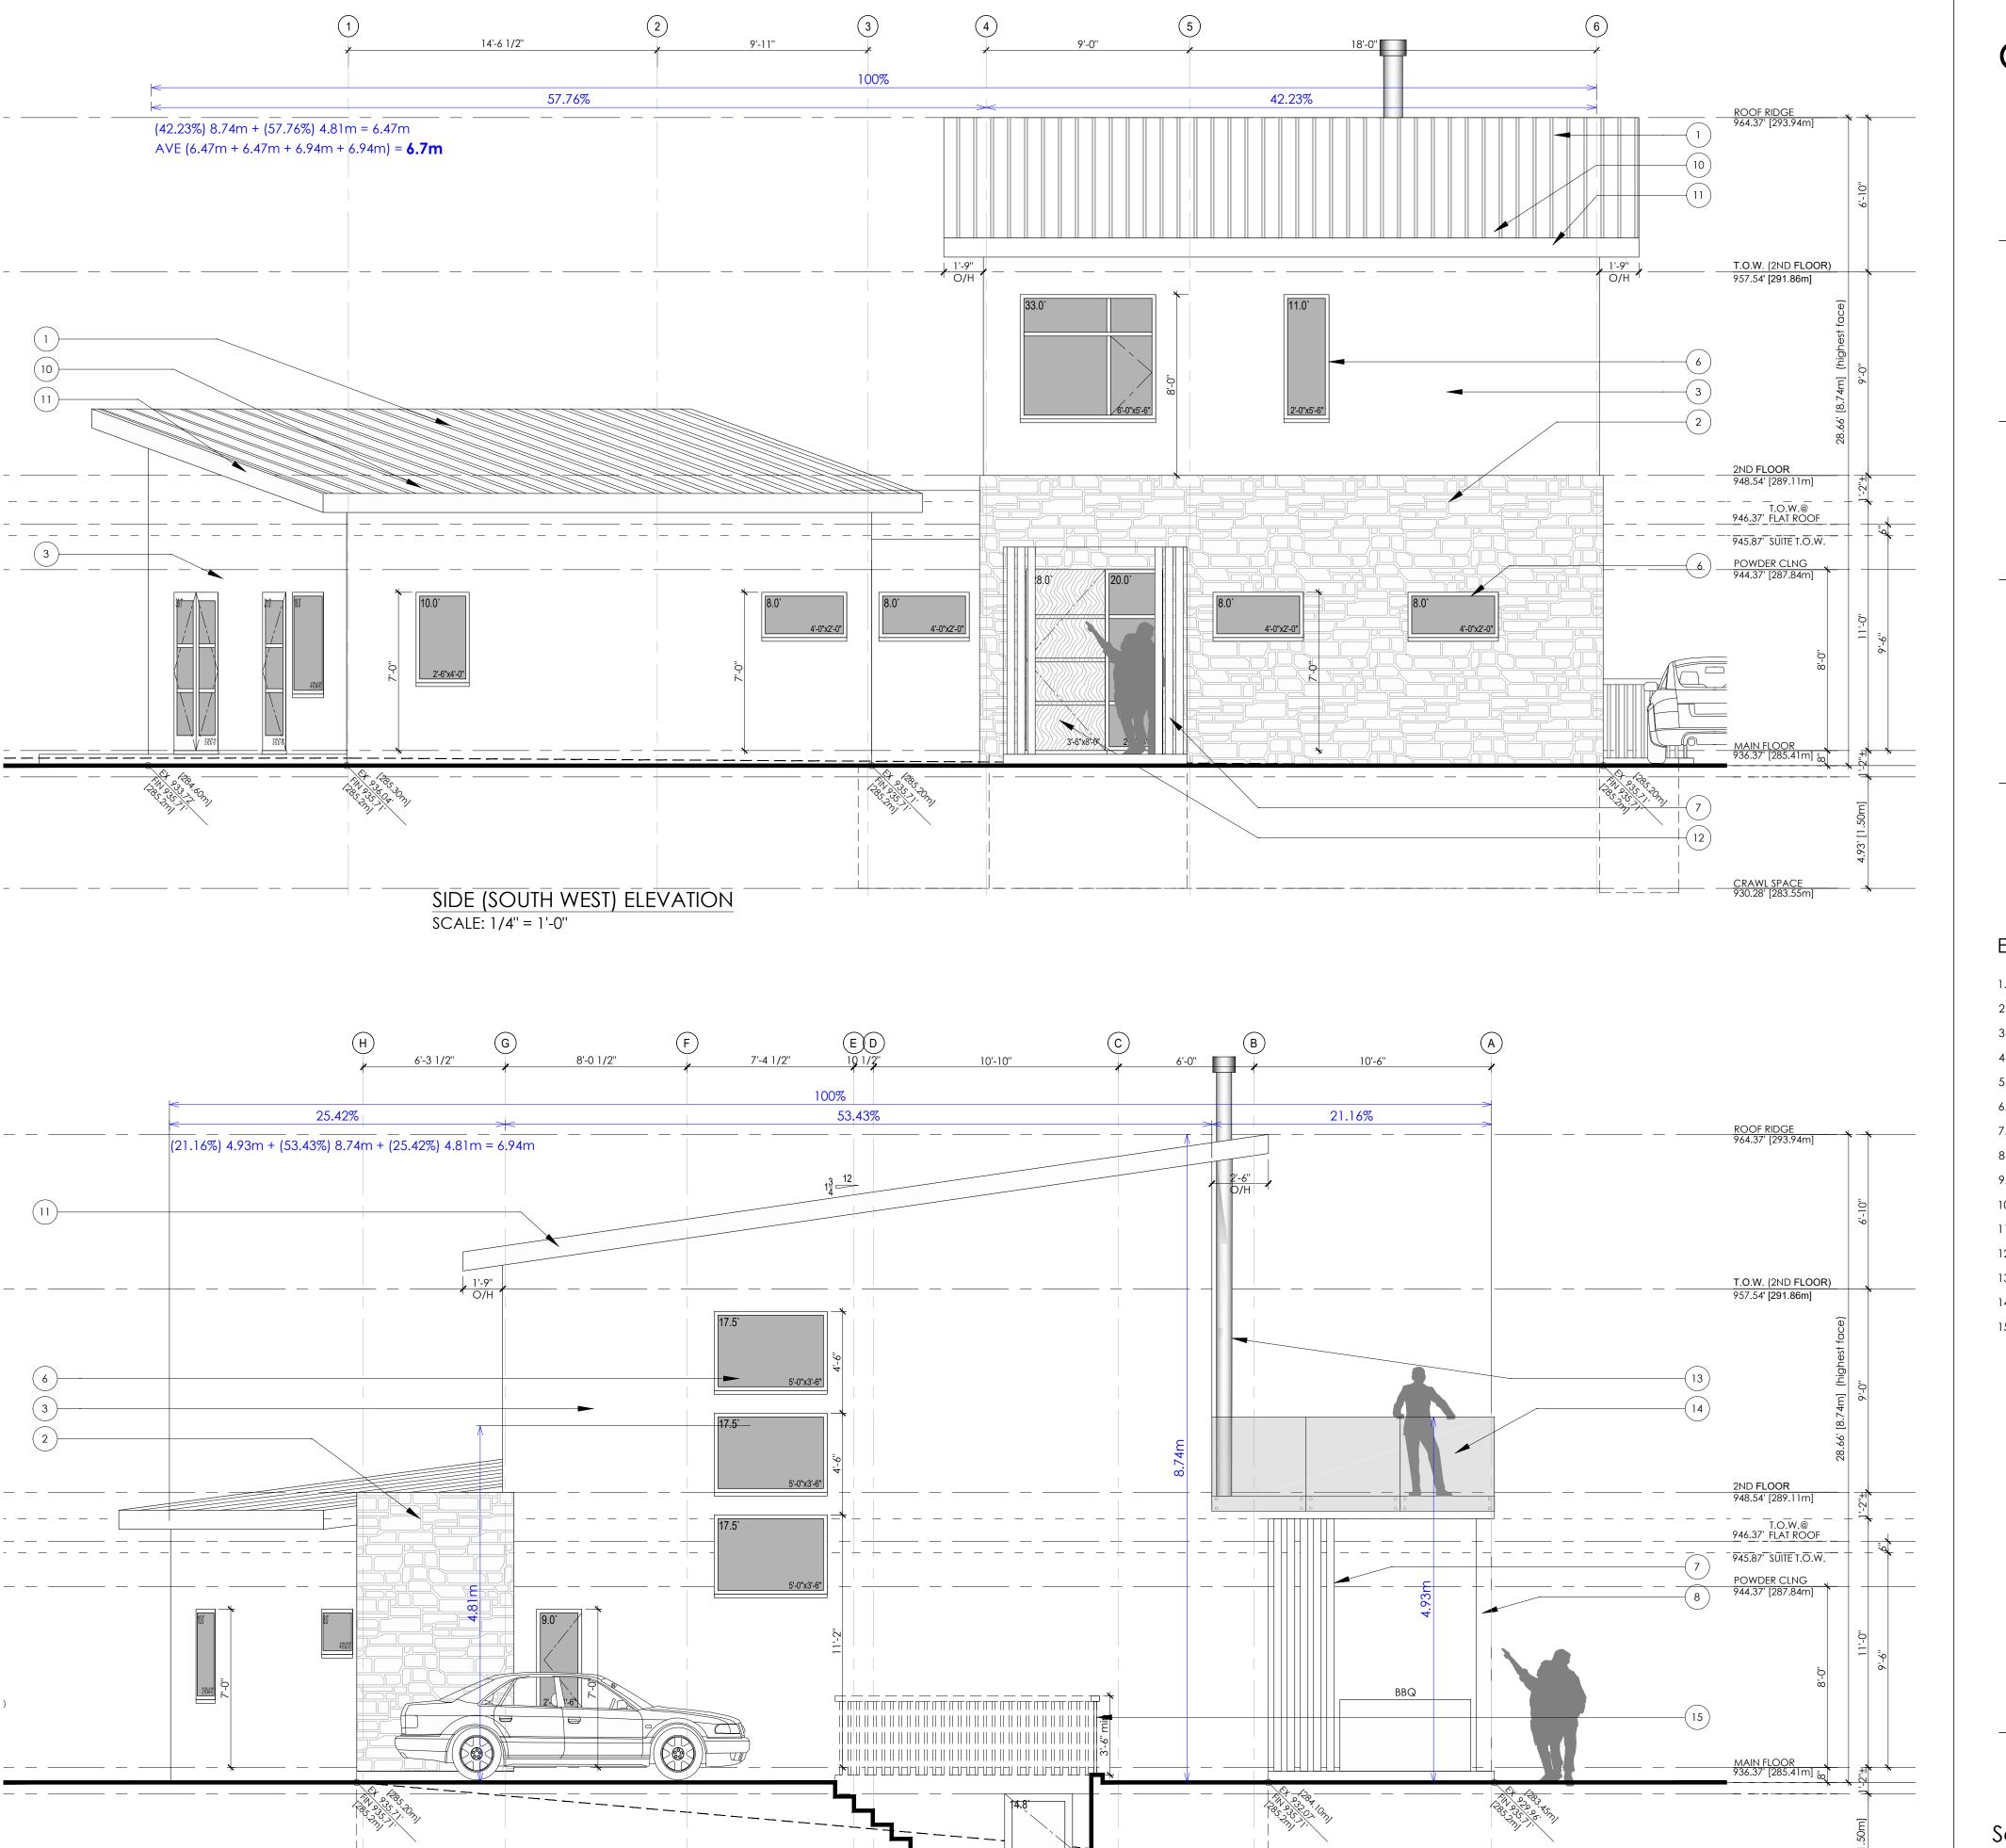

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DRAWING


South West & South East Elevations


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SCALE: 1/4"=1'0"

A2.2



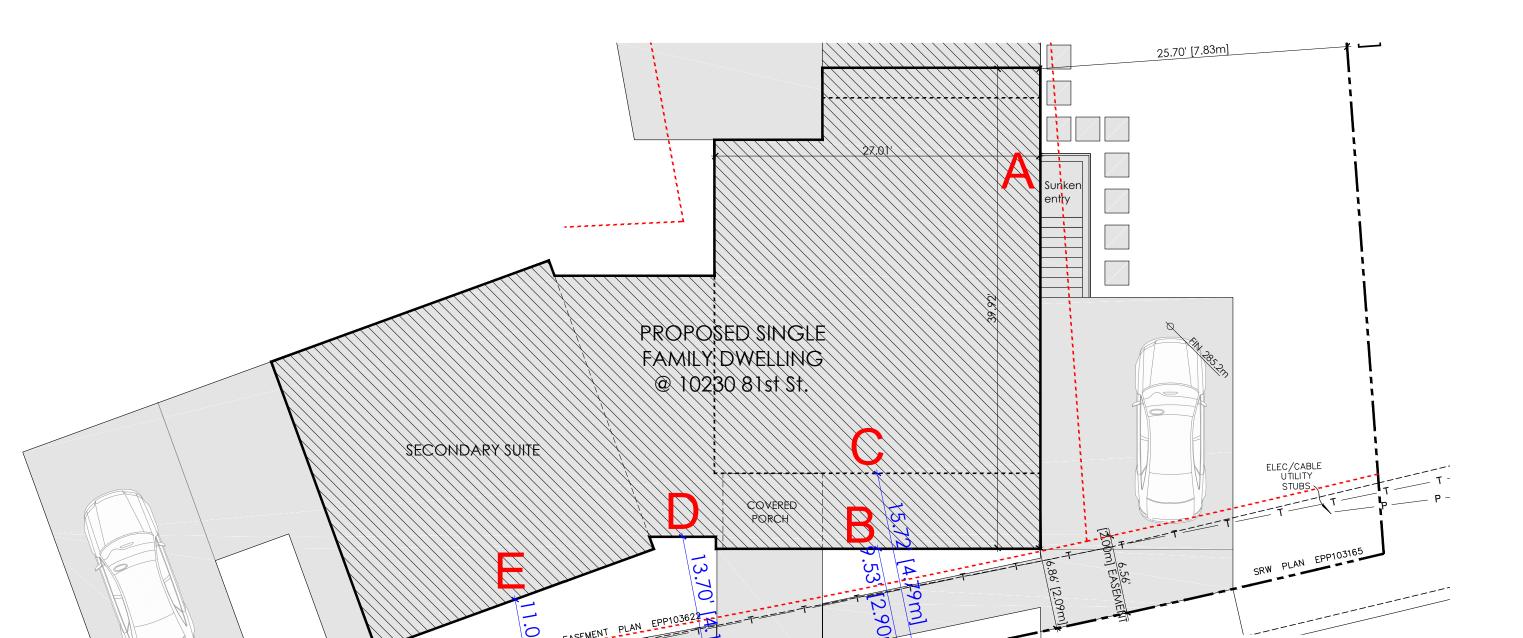

MEDIAN SETBACKS ARE USED FOR FACES THAT ARE NOT PARALLEL TO PROPERTY LINE

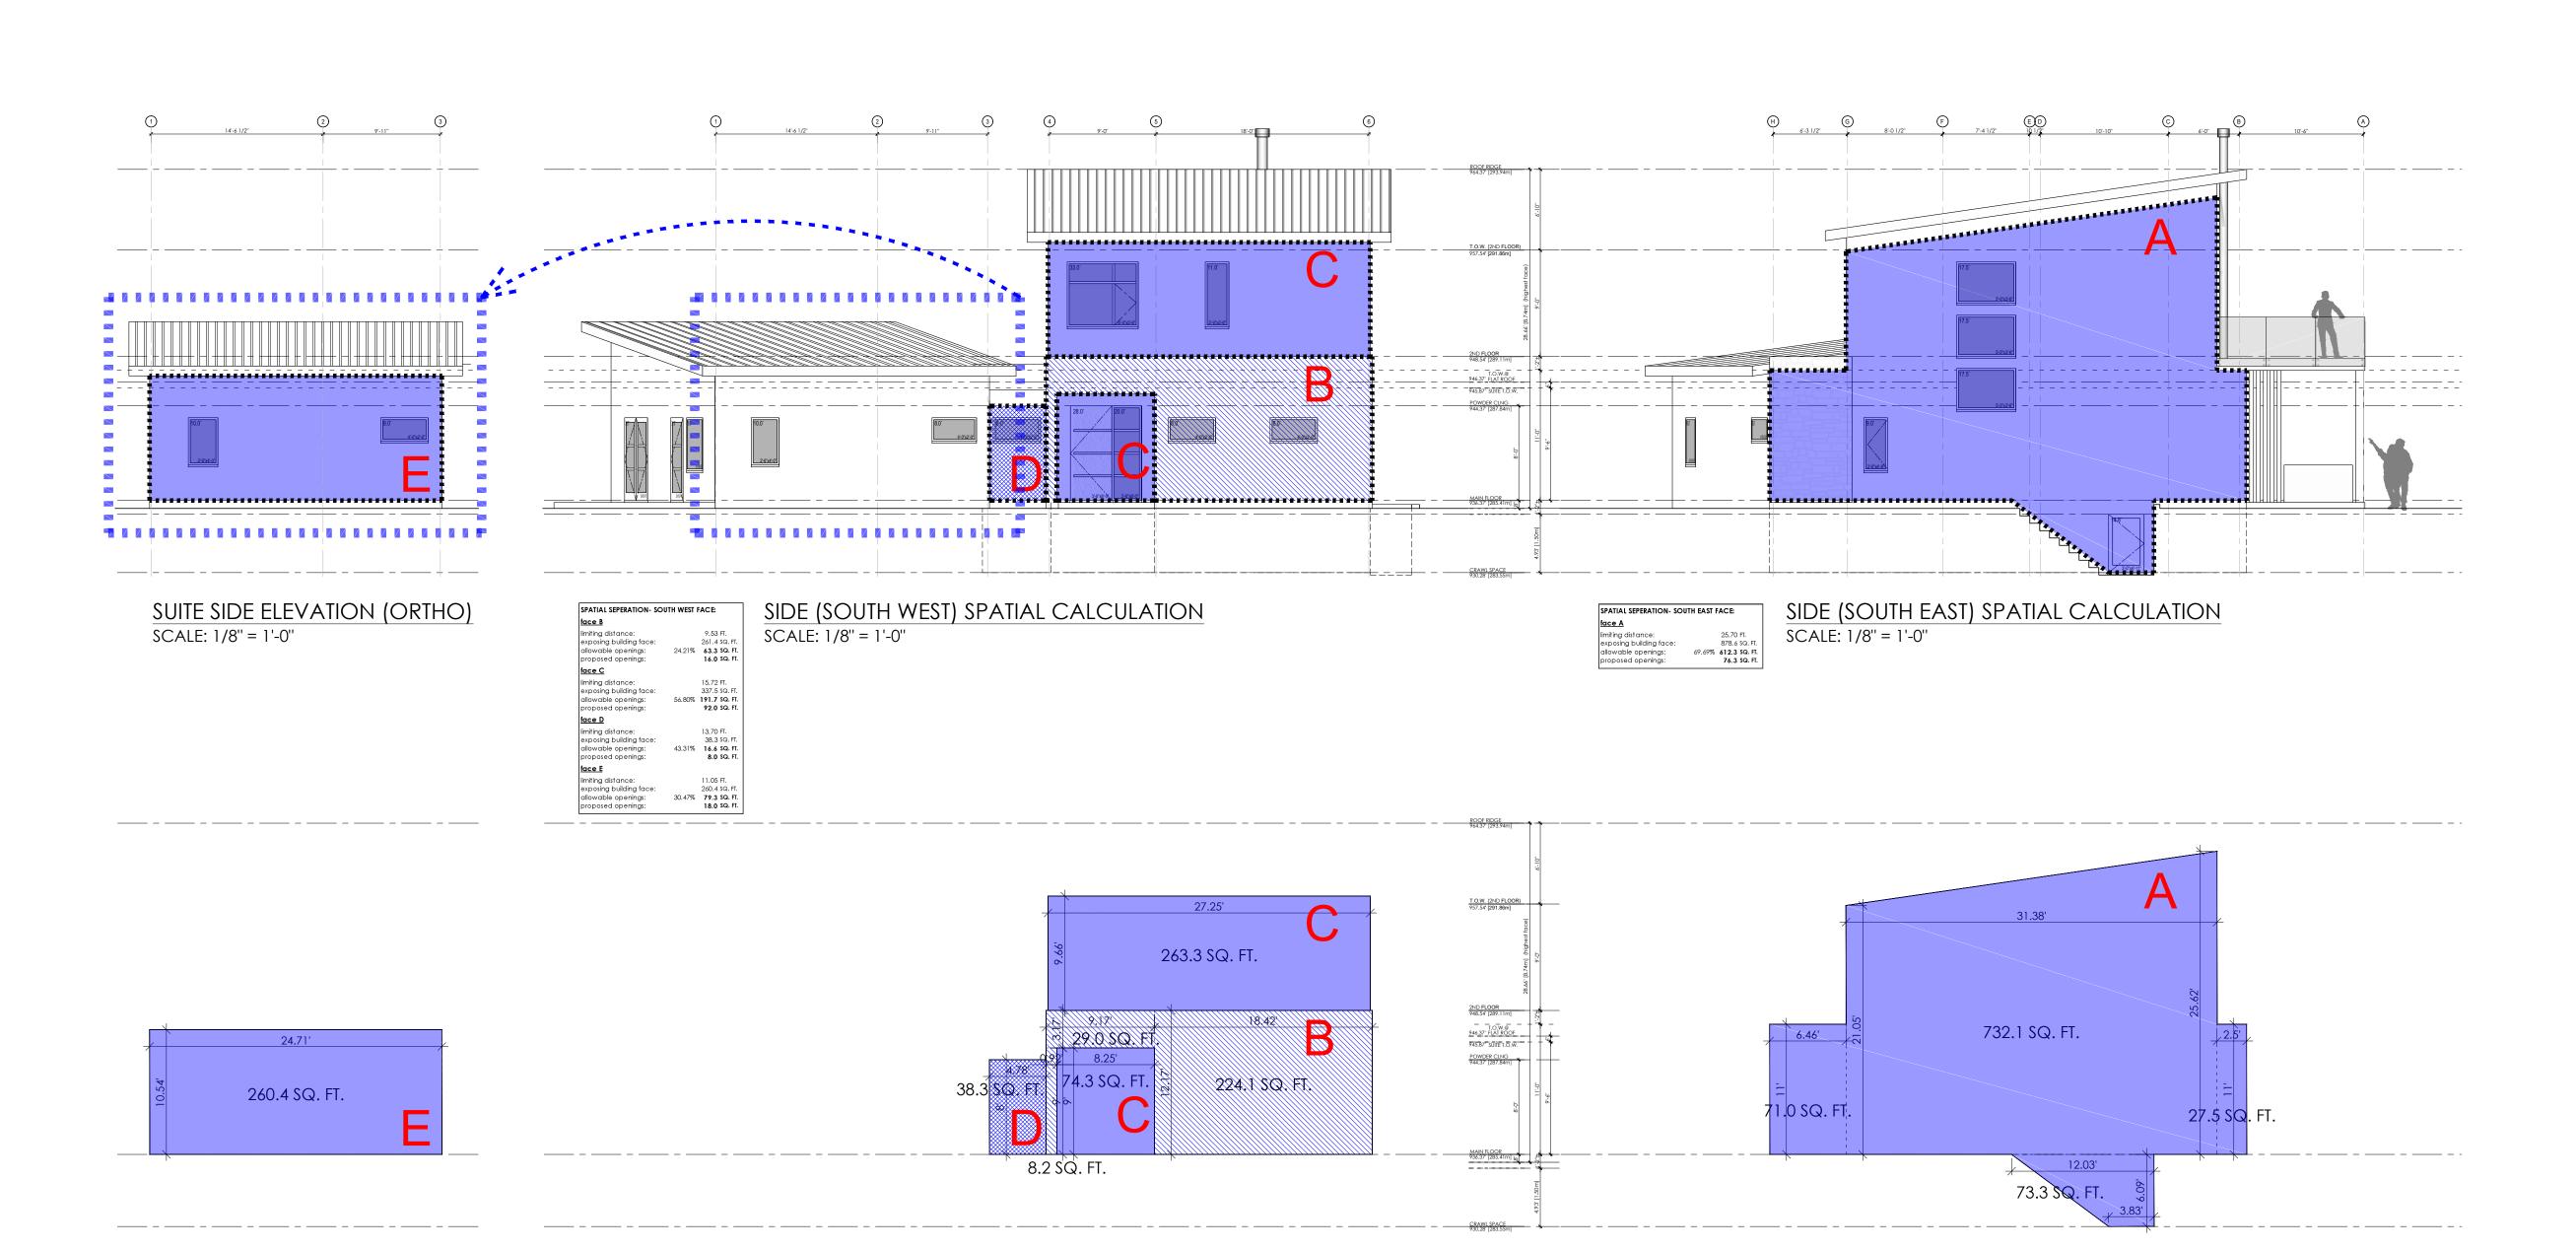1 Partial Site Plan for SW face setabeks



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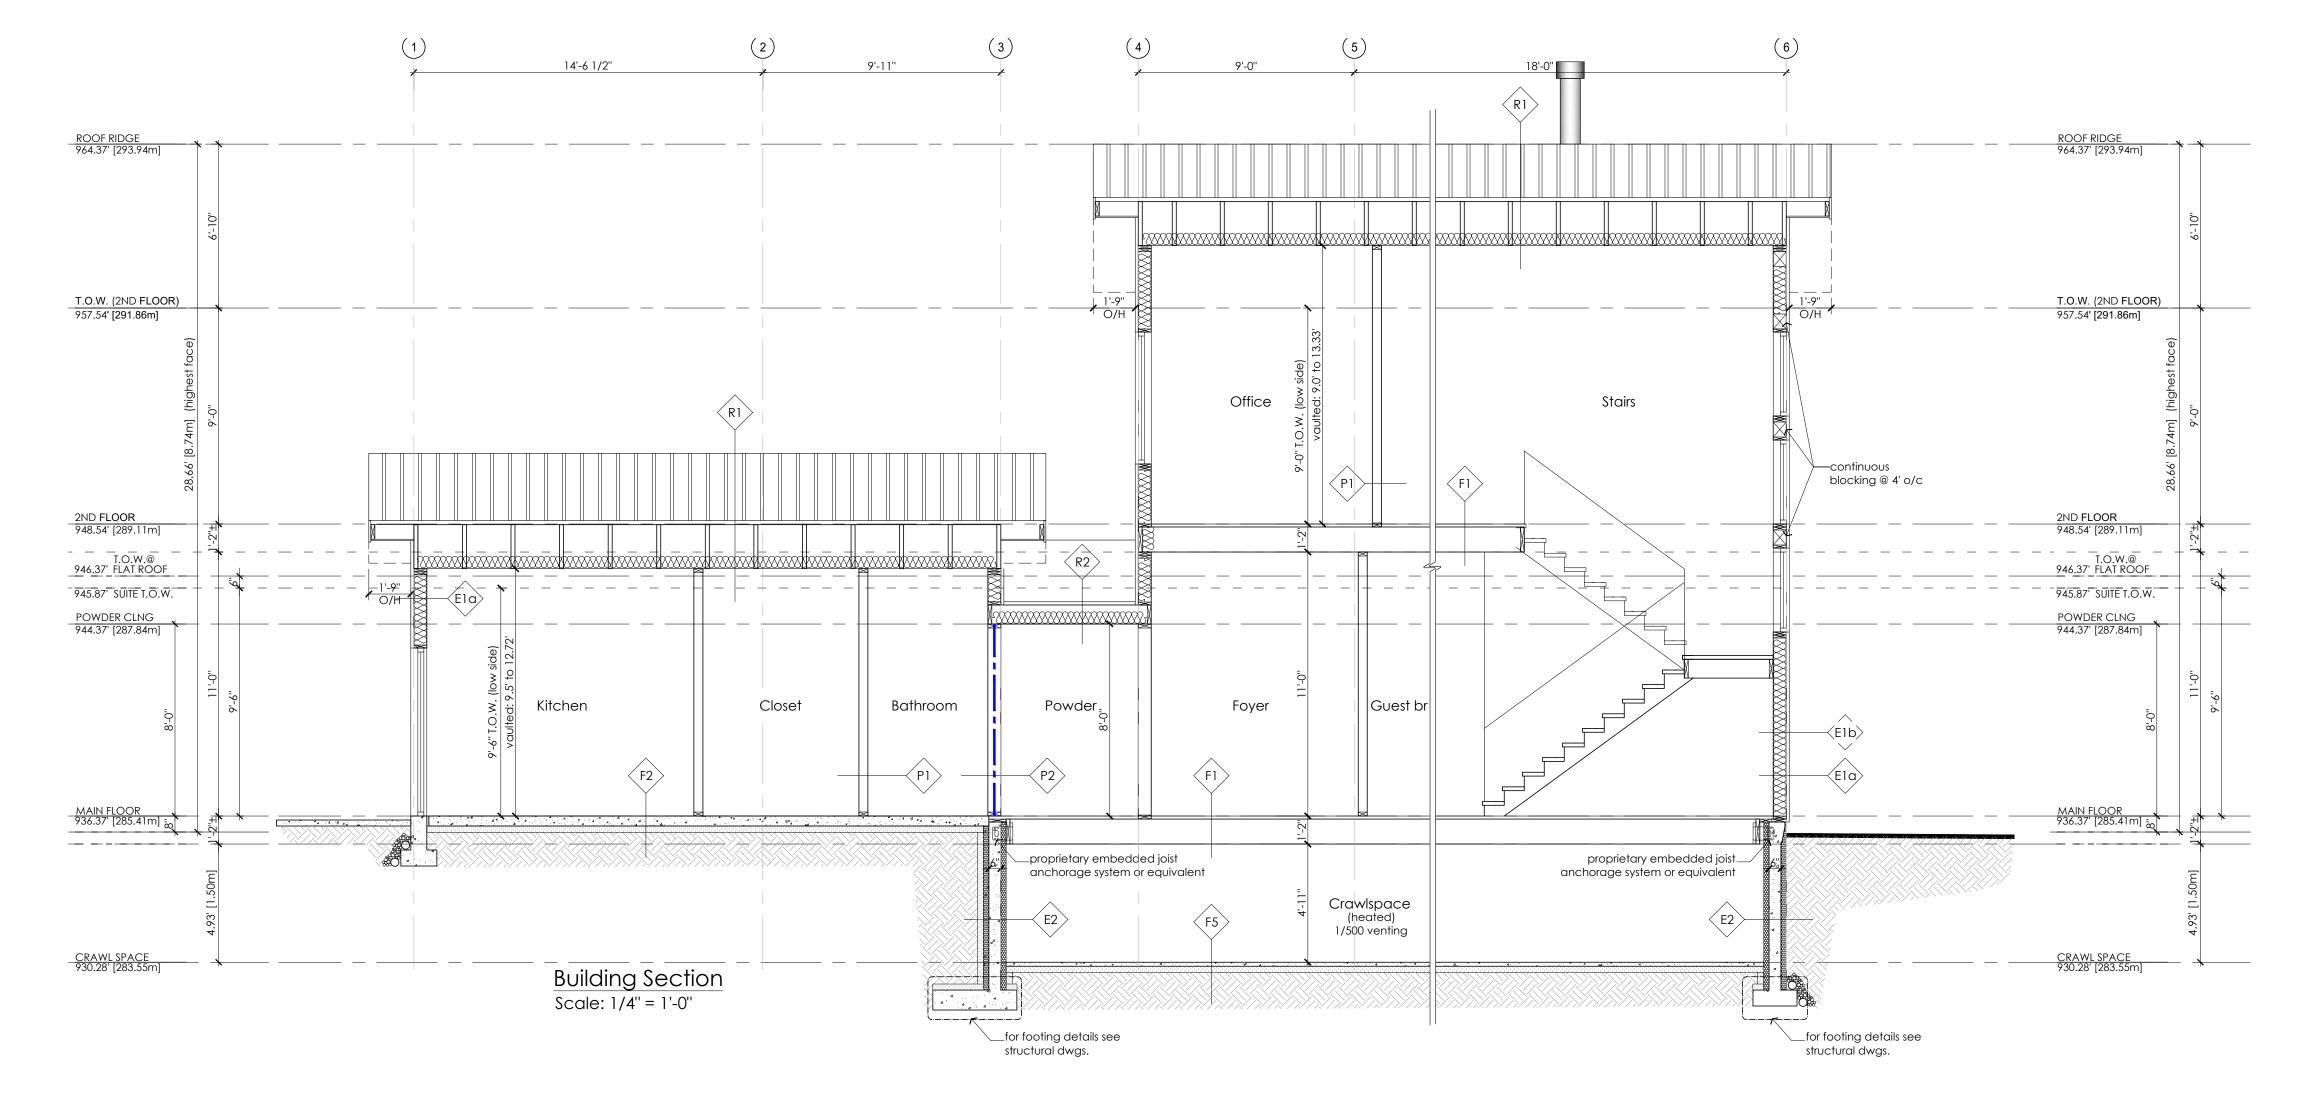
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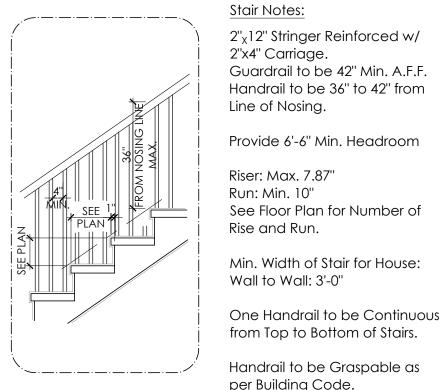
DRAWING

Spatial calulation-SW & SE Elev.

DRAWN BY: CHECKED BY:

SCALE: 1/4"=1'0"






2"_X12" Stringer Reinforced w/ Guardrail to be 42" Min. A.F.F. Handrail to be 36" to 42" from

See Floor Plan for Number of

Min. Width of Stair for House:

Handrail to be Graspable as per Building Code.

1 Stair details (Typ) A3.1 1/2" = 1'-0"

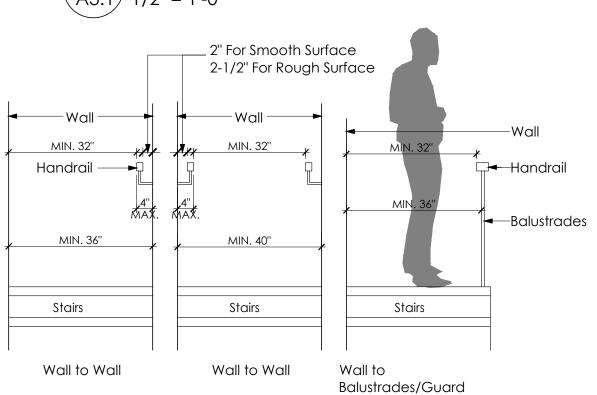

Assembly Schedule

Assembly Schedule

Standing Seam Metal Roofing

Engineered Wood Trusses @ 24" o/c max

R31 HD Batt Insulation (Effective R24)

Torch-On Bituminous Membrane

1-1/2" cross purlins w/ min. 2% slope to

R-28 Batt insulation- effective R24

15 lb. Felt Underlayment

6 Mil Poly Vapour Barrier

Waterproof membrane

6 mil. Poly Vapour Barrier

Waterproof Membrane

1/2" Type 'X' Gypsum

(Vent 1:150)

Plywood Subfloor

2x10 roof rafters

drain

1/2" Type 'X' Gypsum

7/16" Roof Sheathing

R1 Typ. Vaulted 2-1/2" min gap/ Strapping (vent 1:150)

ID Tag Type

Typ. Flat

RSI 4.68

R2 Roof

ID Tag	Туре	Assembly	
TJI Floor F1 System		Finish Floor (As Specified)	
	T II 51	3/4" Plywood Decking	
	11 7/8" Eng Wood Joists @12" o/c		
	1/2" Gypsum		
	(Vent 1:150)		
F2	Found. Slab RSI 2.96	Finish Floor (As Specified)	
		4" CIP Concrete Slab 10mm @12" o/c	
		6 mil Poly Vapour Barrier	
		3" Rigid XPS Insulation R15	
		6" Min. Compacted Granular Fill	

	Assembly Schedule	
ID Tag	Туре	Assembly
		Composite Decking
		Torch-On Bituminous Membrane
		Waterproof membrane
		Plywood Subfloor
		1-1/2" cross purlins w/ min. 2% slope to
	Deck over Living Space RSI 4.68	drain (Vent 1:150)
F3		2x10 Floor joists @ 12" o/c
		R-32 Batt insulation
		6 mil. Poly Vapour Barrier
		Waterproof Membrane
		Aluminum Soffit
		Composite Decking
	Deck	Torch-On Bituminous Membrane
		Waterproof membrane
F4 Deck		Plywood Subfloor
		2x10 Floor joists @ 12" o/c
	Aluminum Soffit	
		2"Conc. skim coat
F5	Crawlspace Slab	Vapour Retarder
ΓЭ	RSI 2.31	R12 Rigid Insulation

Compact fill or Sand solid bearing

	Wall Schedule		
ID Tag	Туре	Assembly	
		Ext. Finish (3/4")- Stucco	
Ela	Ext. Wall RSI 3.02	5/8" Plywood sheathing 2X6 Wood Studs @ 16" O.C. min. R22 Insulation 6 mil Poly. Vapour Barrier 1/2" Gypsum Stone Cladding 1/2" Scratch Coat	
Elb	Ext. Wall RSI 3.01	Delta Vent SA, Peel & Stick Housewrap or similar 5/8" Plywood sheathing 2X6 Wood Studs @ 16" O.C. min. R22 Insulation 6 mil Poly. Vapour Barrier 1/2" Gypsum	
E2	Found. Wall RSI 4.87	Drainage Mat Bituminous Damp-Proof Memb. 2 5/8" ICF Rigid Panel 6" Concrete Foundation Wall 25 MPa min. 2 5/8" ICF Rigid Panel	
Pl	2x4 Partition	1/2" Gypsum 2x4 Framing @ 24" o/c 1/2" Gypsum	
P2	1 hr F.R.R. Interior Wall BCBC W3A STC 45	5/8" Type "X" Gypsum Board 2x4 Studs @ 16" o/c Absorbtive material in cavity Resilient Channel @ 16"/24" o/c 5/8" Type "X" Gypsum Board	



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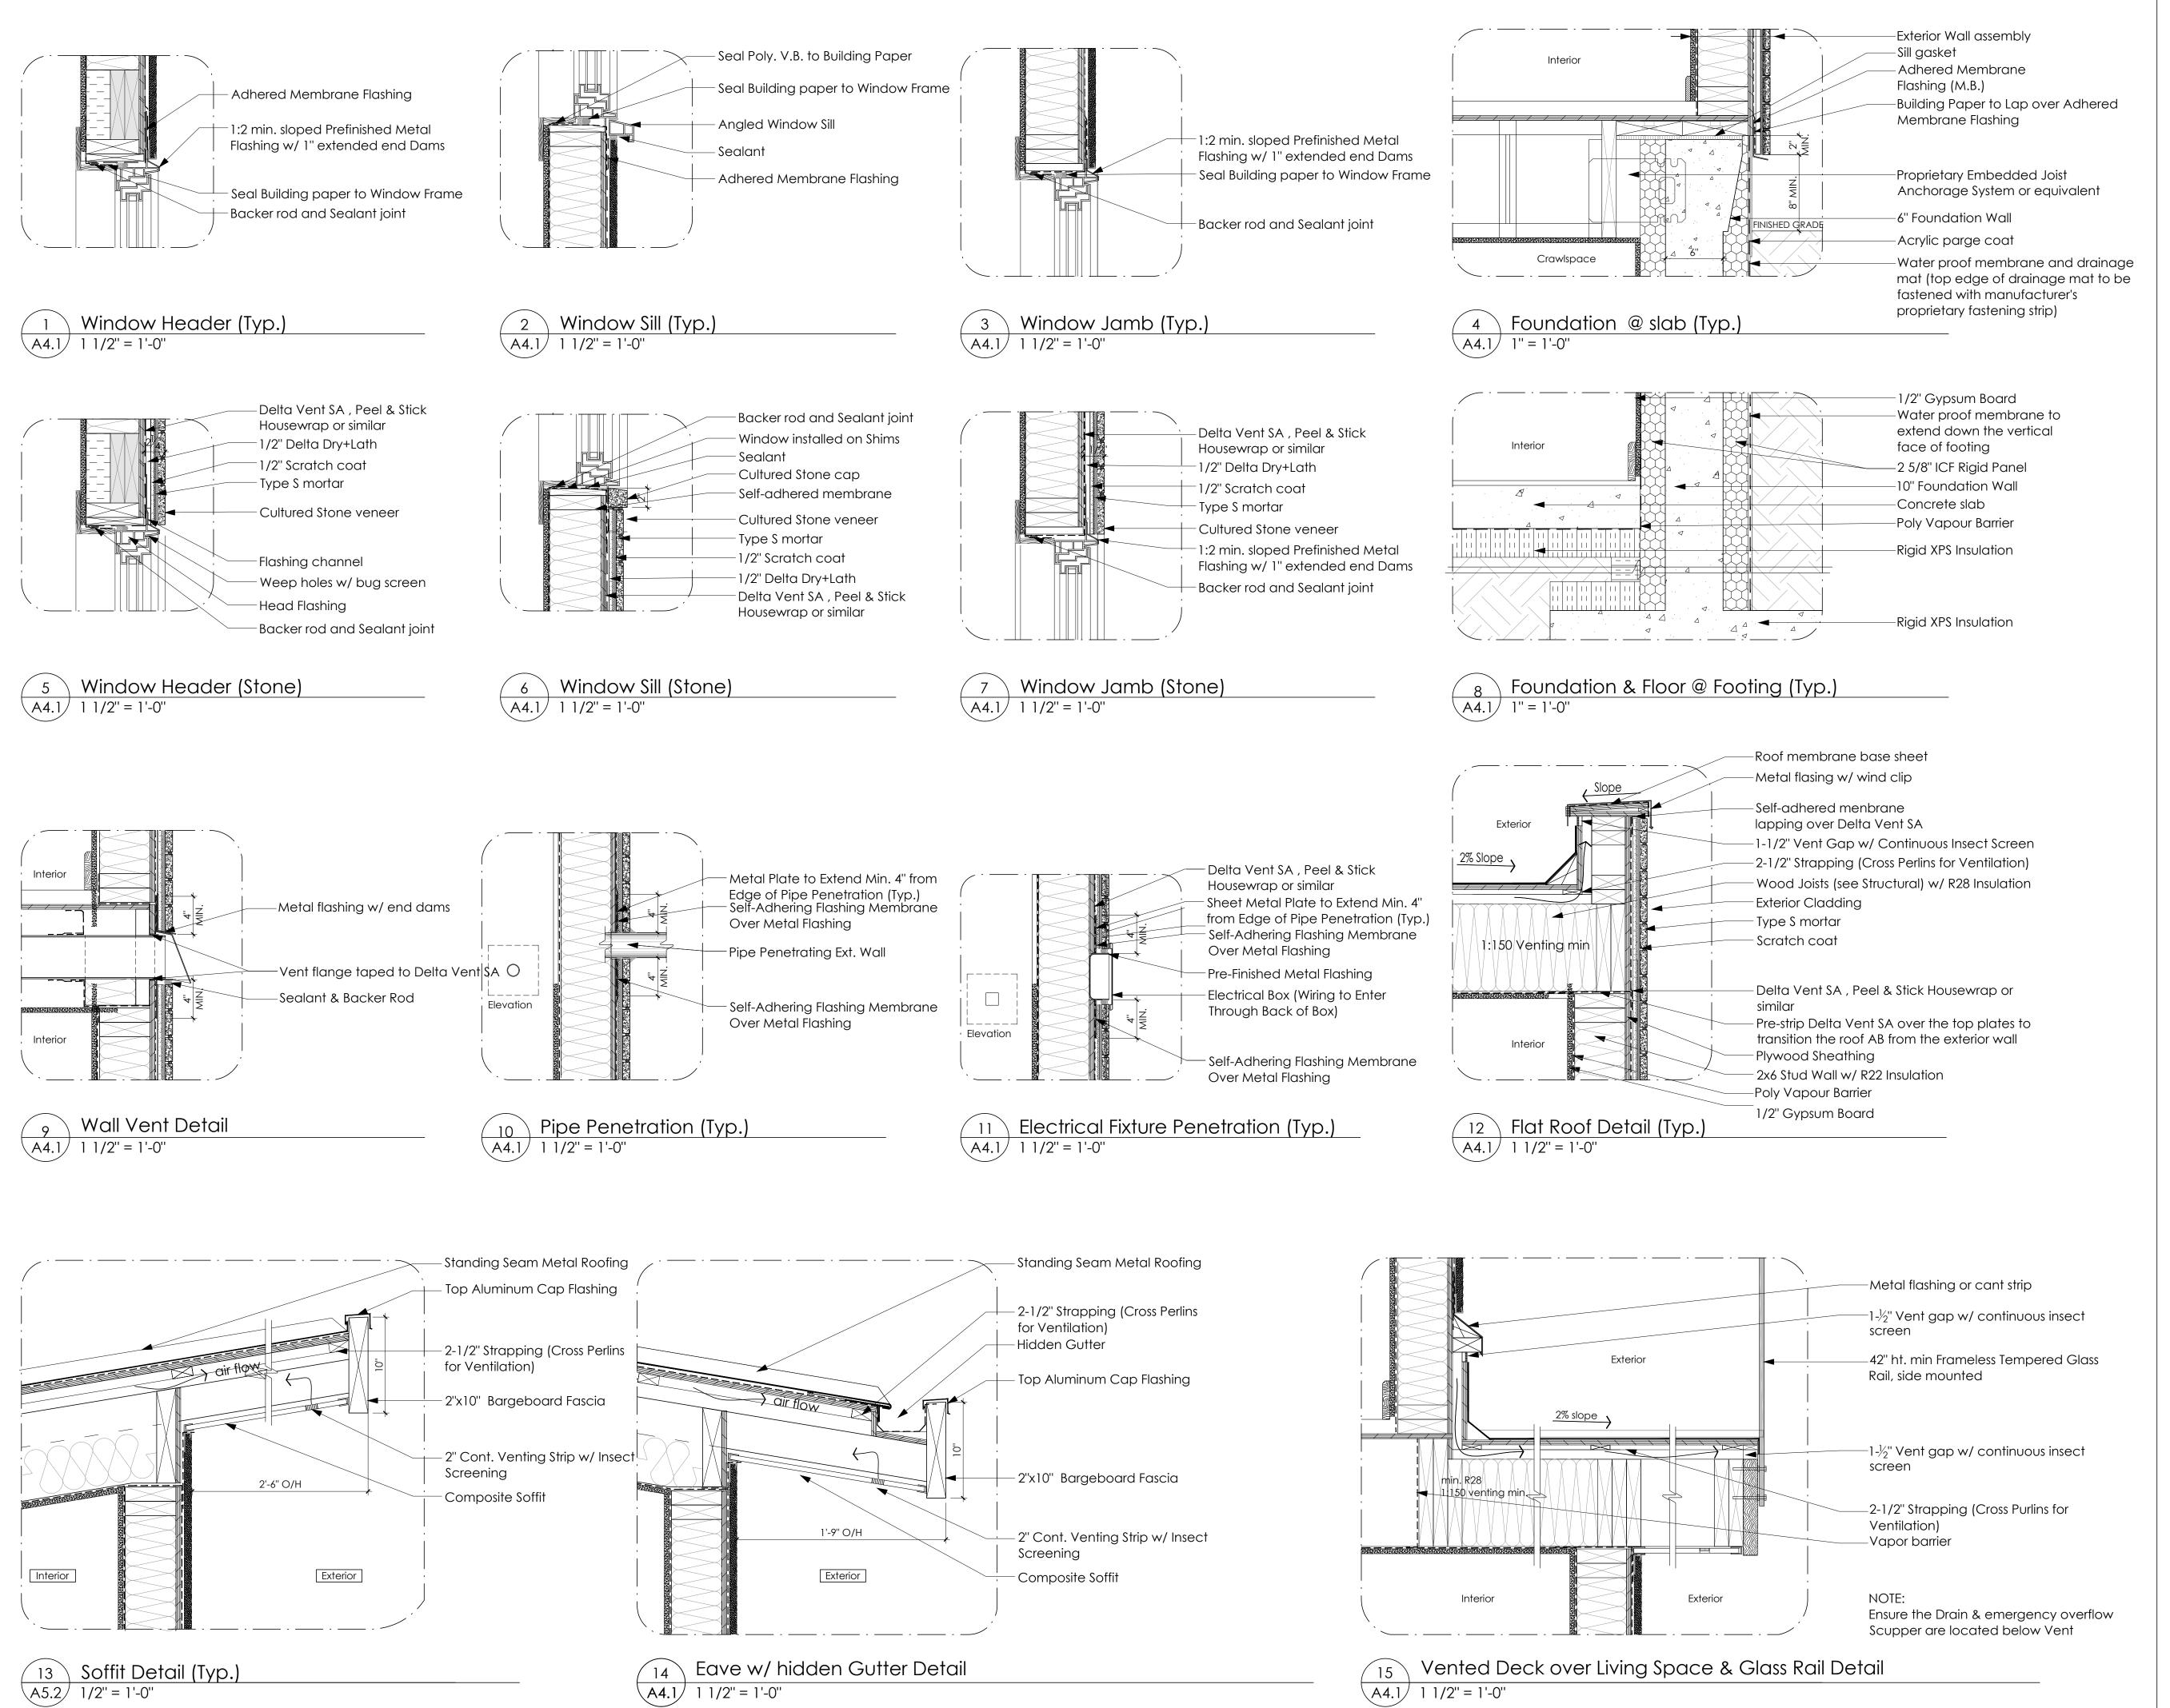
NOTES

DRAWING

Building Section

MM SHEET: DRAWN BY: KΑ CHECKED BY: SCALE: 1/4"=1'0"

DATE: 01 MAY 21



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Typical Details

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A4.1