



These designs and drawings are copyright Devise Design Inc. and cannot be used or copied, in full or in portion, without written Verify all dimensions, datums and levels prior to construction. Report any discrepancies or omissions immediately. Do not scale th All work must comply with the most recent edition of the BC building code and any other governing authorities.

PROJECT

SEGEV RESIDENCE

10230 - 81st STREET, OSOYOOS, BC

ISSUED

A Issued for DP/BP

10 JUN 21

REVISIONS

NOTES

DISCLAIN

these drawings are intended for design reference only, and are not to be used as construction or permit drawings or for any purpose beyond their initial intent.

all information included in this drawing package is to be verified with the permitted construction drawings and confirmed with the owner.

devise design inc. waives any and all liability associated with the use of these drawings

DRAWING

Main Floor Plan


DRAWN BY: MM

CHECKED BY: KA

SCALE: 1/4"=1'0"

DATE: 01 MAY 21



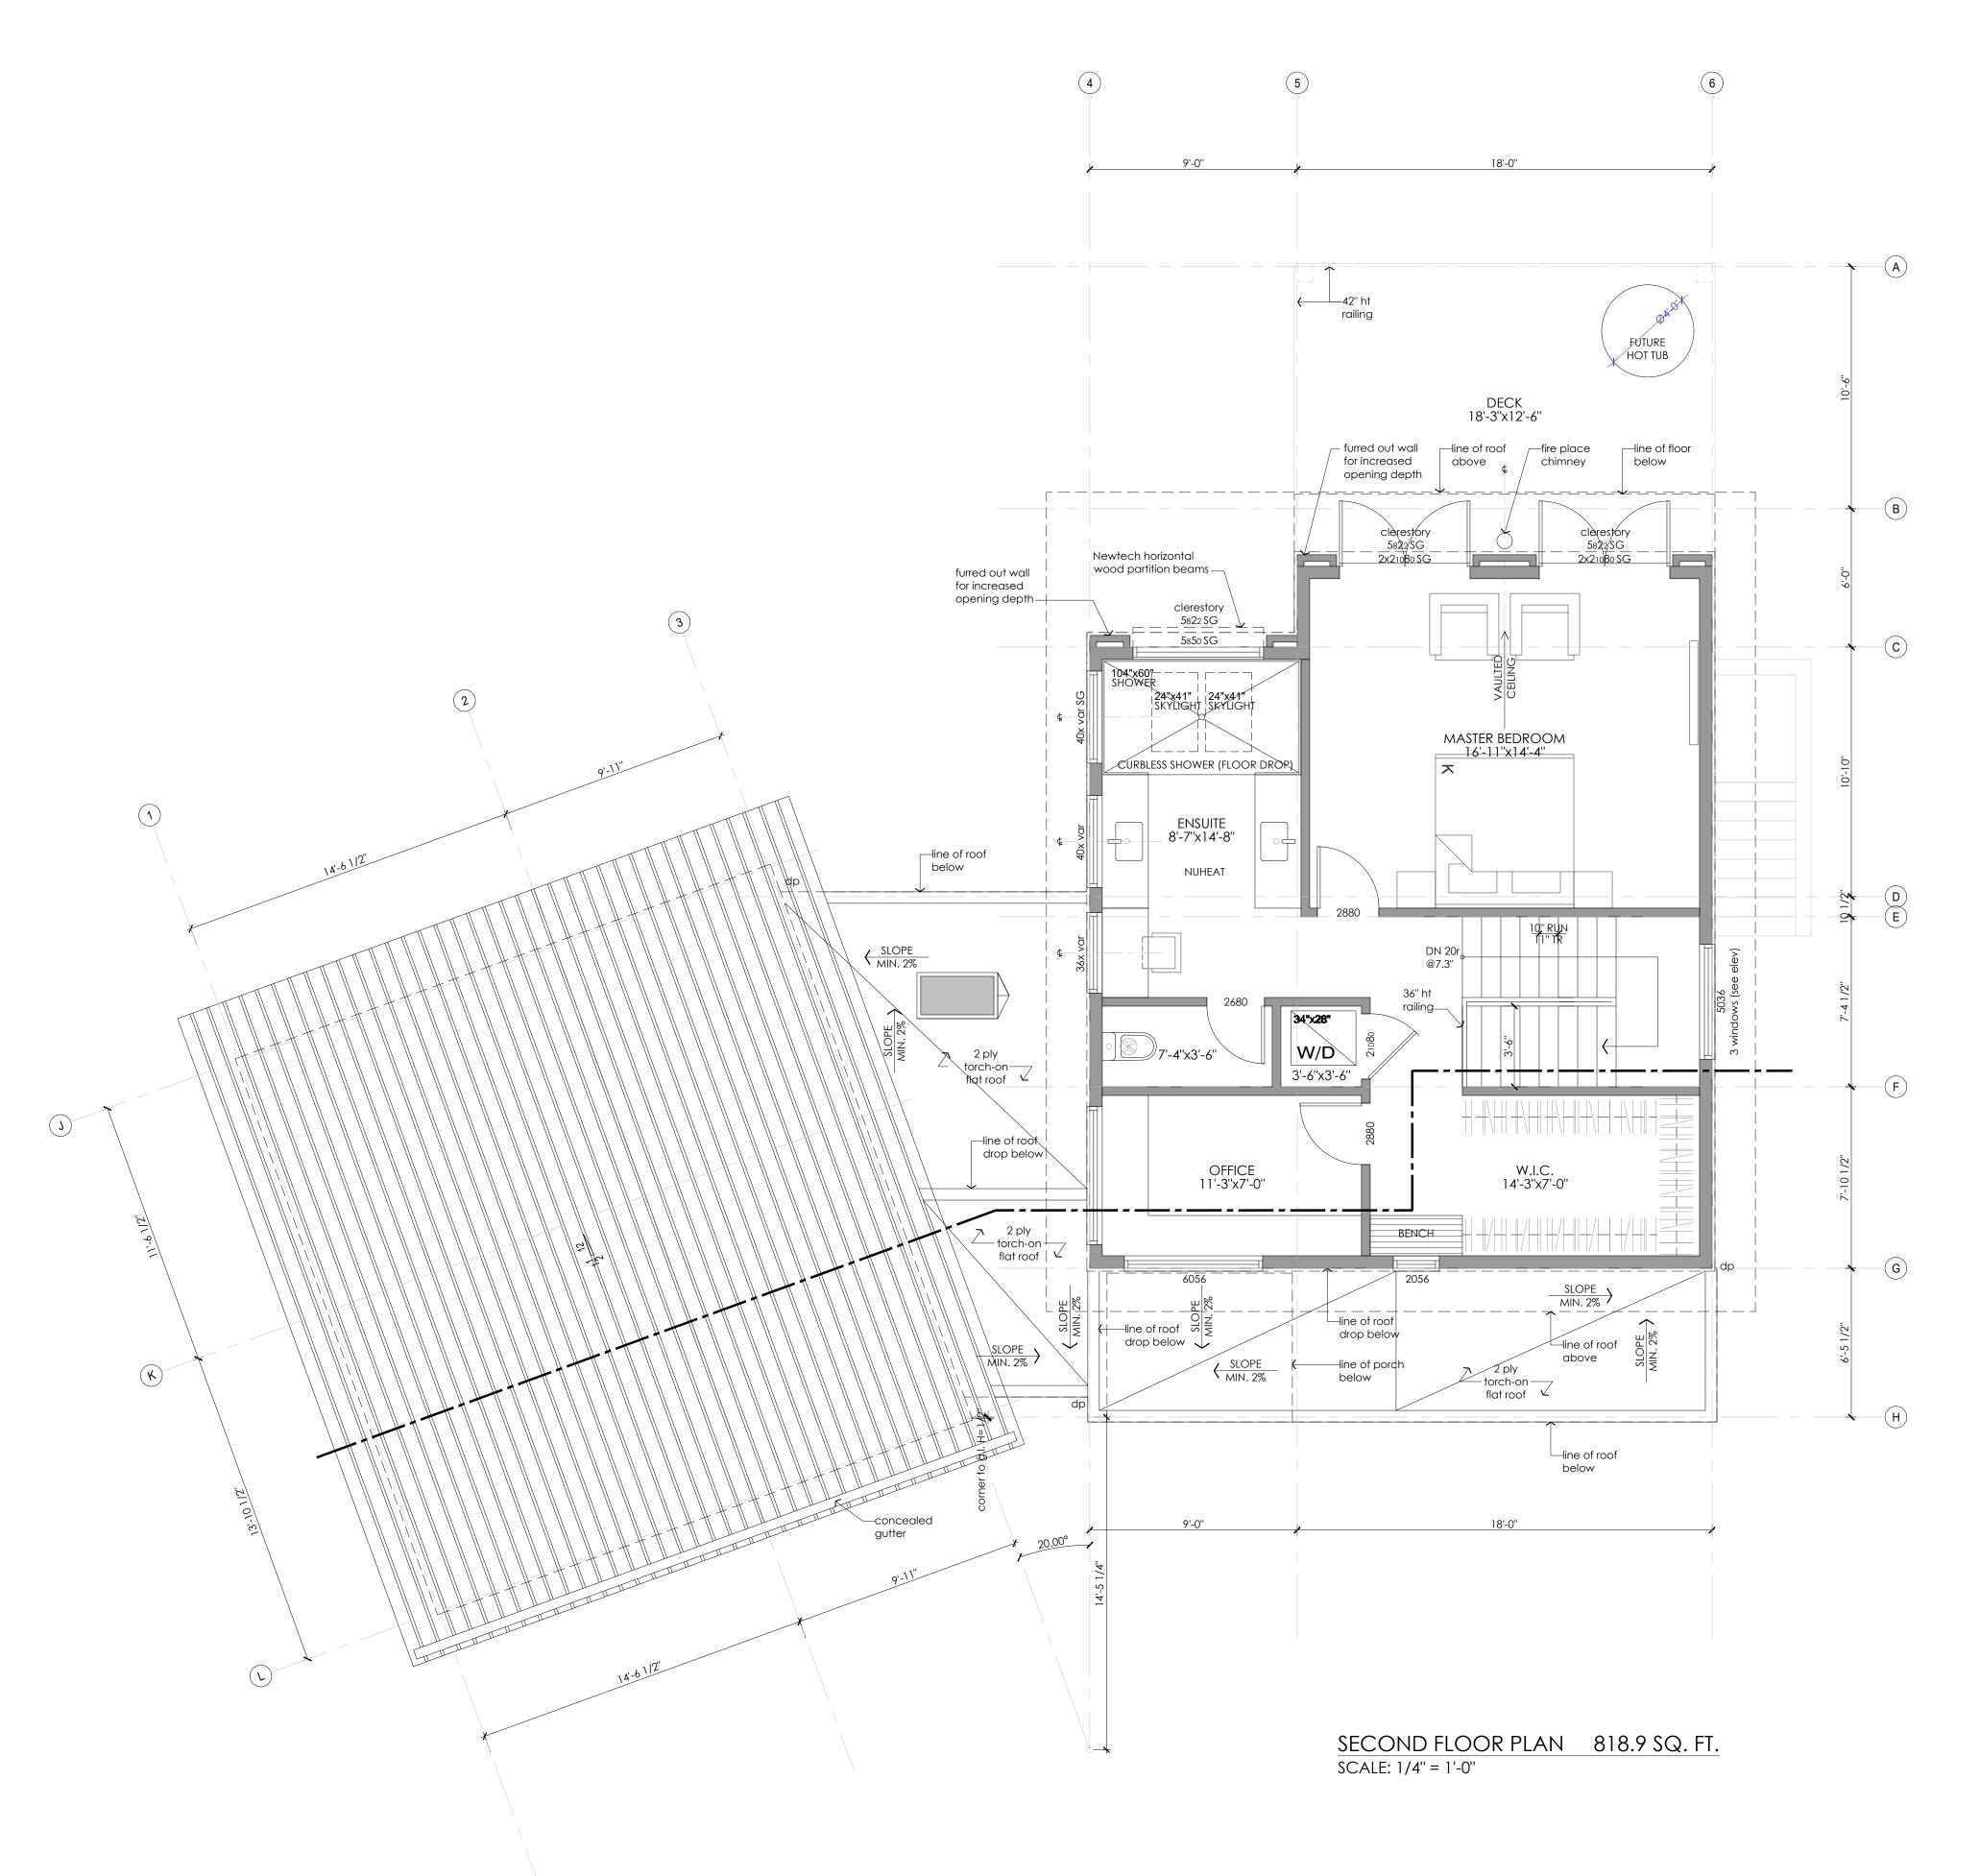



These designs and drawings are copyright Devise Design Inc. and cannot be used or copied, in full or in portion, without written Verify all dimensions, dotums and levels prior to construction. Report any discrepancies or origins immediately. Do not scale his All work must comply with the most recent edition of the RC building code and any other arowards are the construction.

PROJECT

SEGEV RESIDENCE

10230 - 81st STREET, OSOYOOS, BC

ISSUED

A Issued for DP/BP

10 JUN 21

REVISIONS

NOTES

DISCLAIN

these drawings are intended for design reference only, and are not to be used as construction or permit drawings or for any purpose beyond their initial intent.

all information included in this drawing package is to be verified with the permitted construction drawings and confirmed with the owner.

devise design inc. waives any and all liability associated with the use of these

DRAWING

Upper Floor Plan


DRAWN BY: MM

CHECKED BY: KA

SCALE: 1/4"=1'0"

DATE: 01 MAY 21



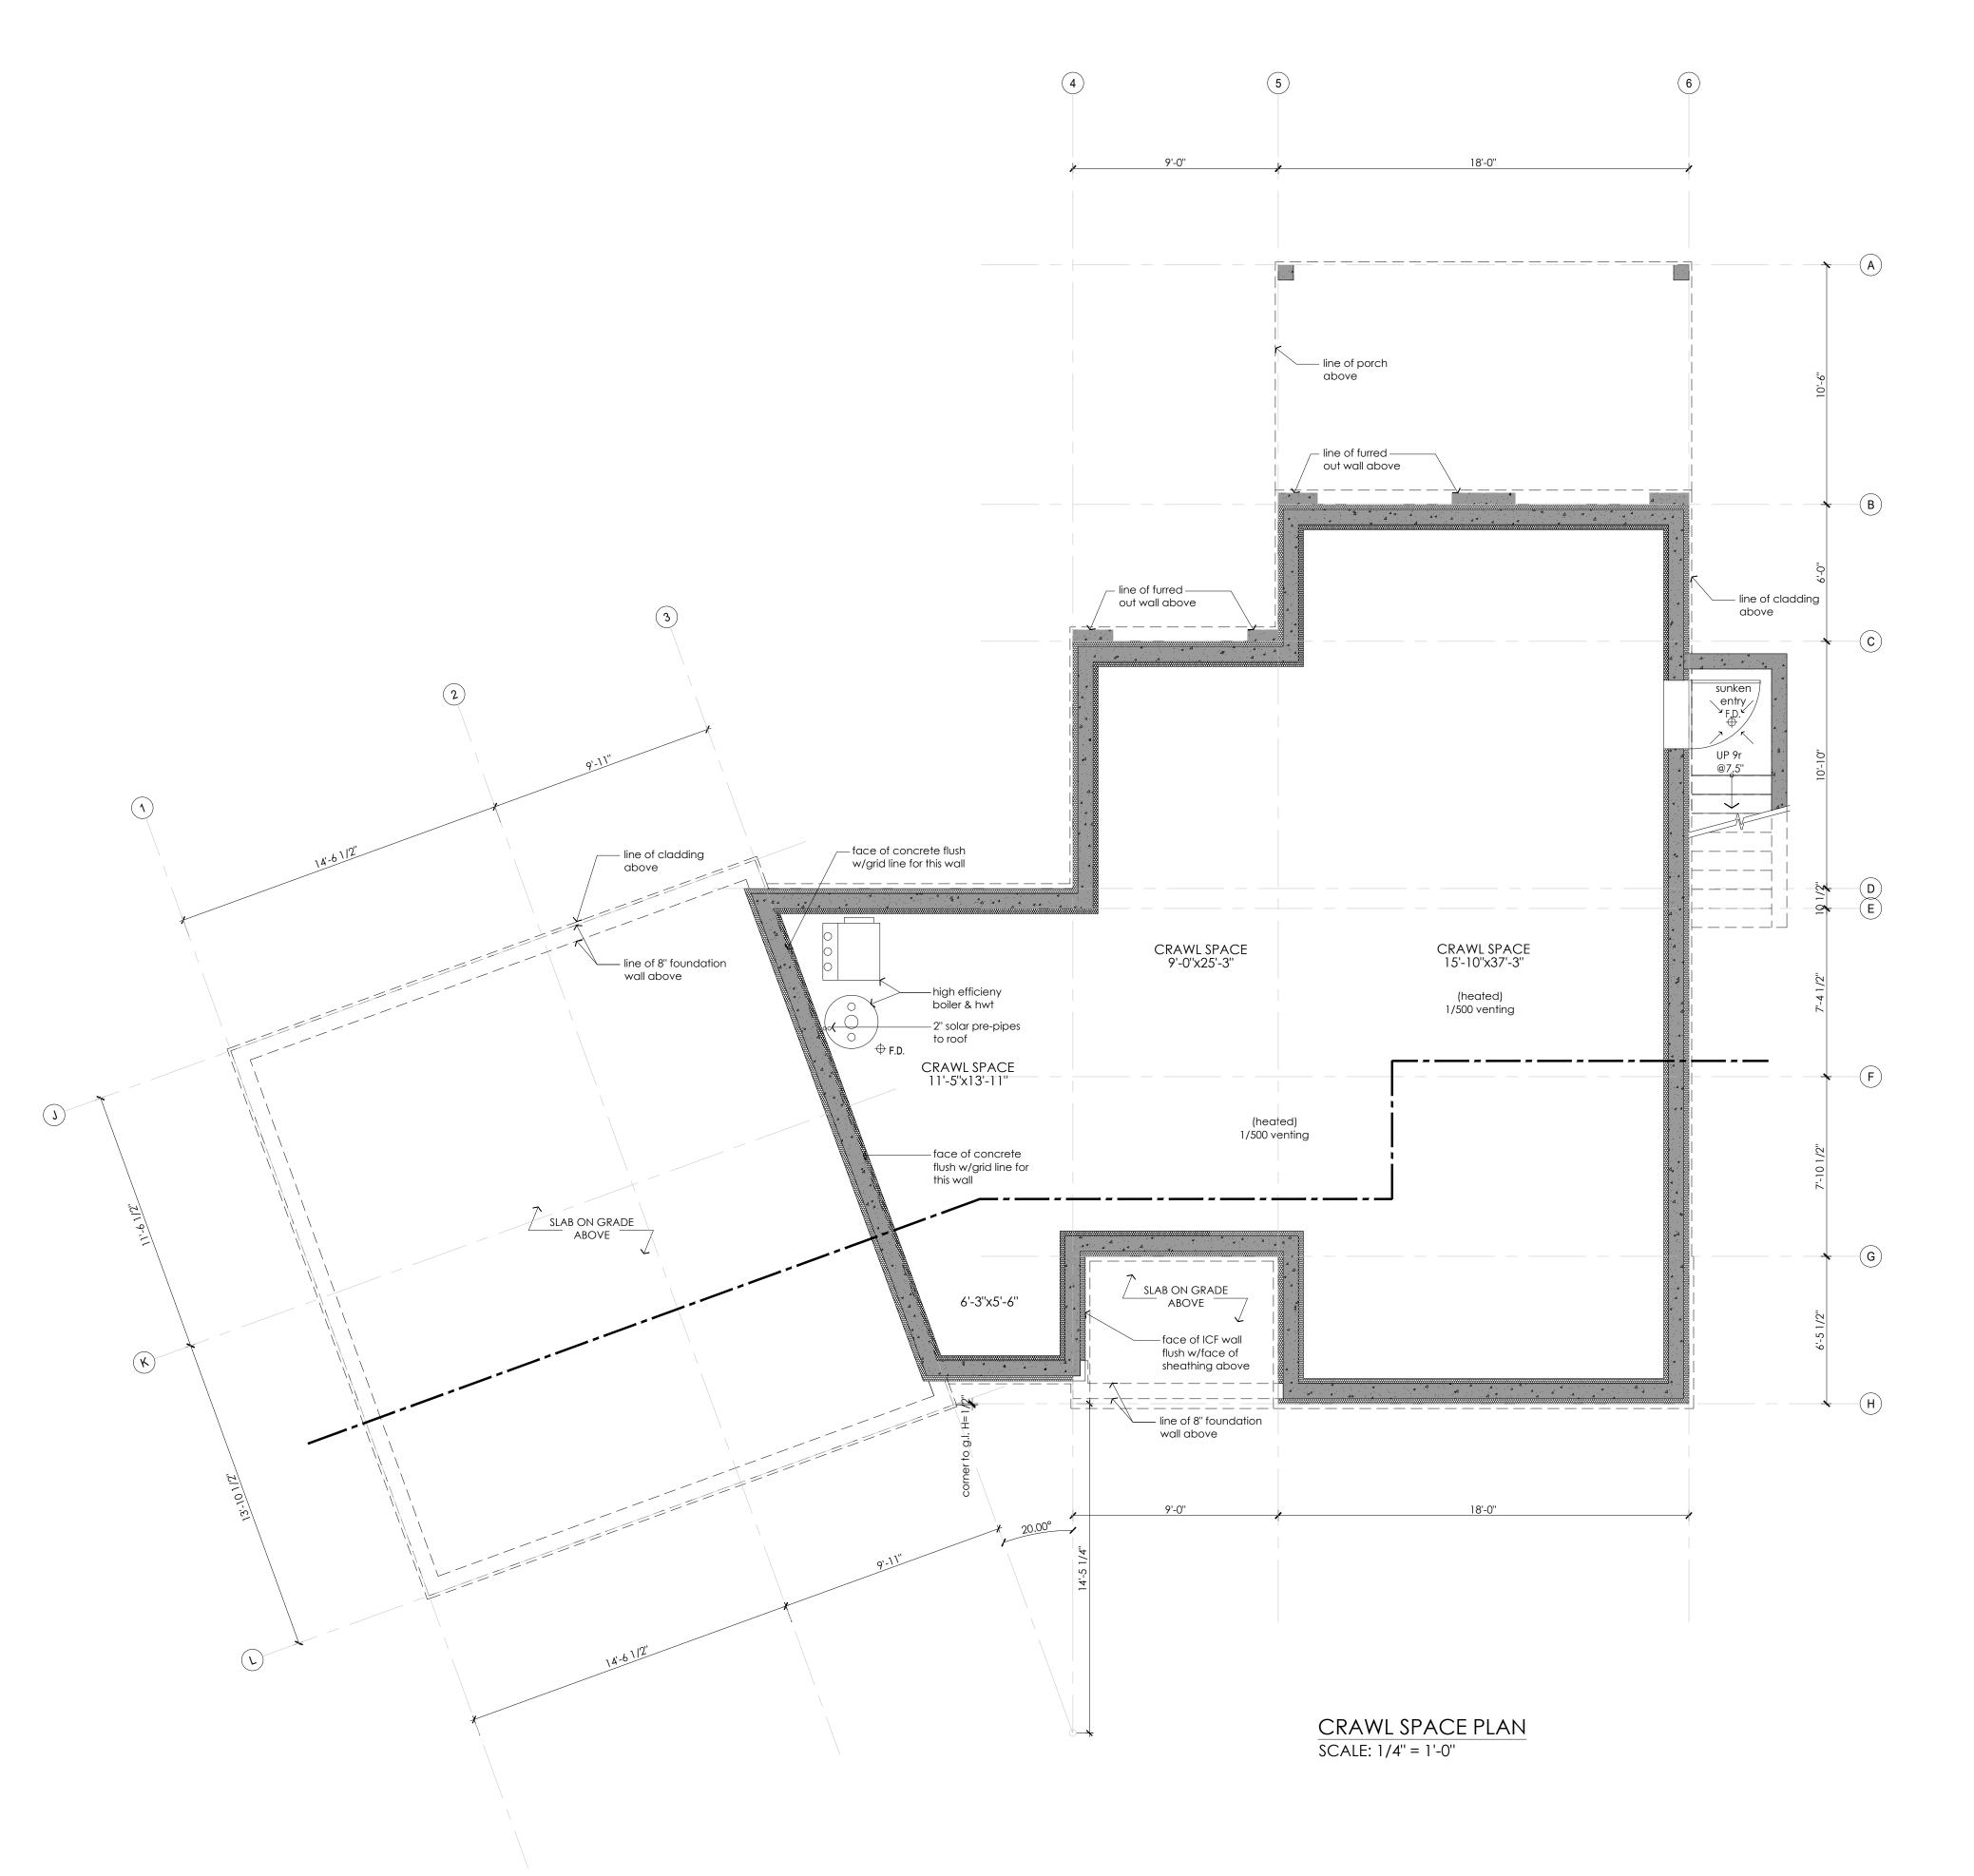



These designs and drawings are copyright Devise Design Inc. and cannot be used or copied, in full or in portion, without written Verify all dimensions, datums and levels prior to construction. Report any discrepancies or omissions immediately. Do not scale th All work must comply with the most recent edition of the BC building code and any other governing authorities.

PROJECT

SEGEV RESIDENCE

10230 - 81st STREET, OSOYOOS, BC

ISSUED

A Issued for DP/BP

P/BP 10 JUN 21

REVISIONS

NOTES

DISCLAIN

these drawings are intended for design reference only, and are not to be used as construction or permit drawings or for any purpose beyond their initial intent.

all information included in this drawing package is to be verified with the permitted construction drawings and confirmed with the owner.

devise design inc. waives any and all liability associated with the use of these drawings

DRAWING

Crawl Space Plan

DRAWN BY: MM


CHECKED BY: KA

CHECKED BY: KA

SCALE: 1/4"=1'0"

DATE: 01 MAY 21



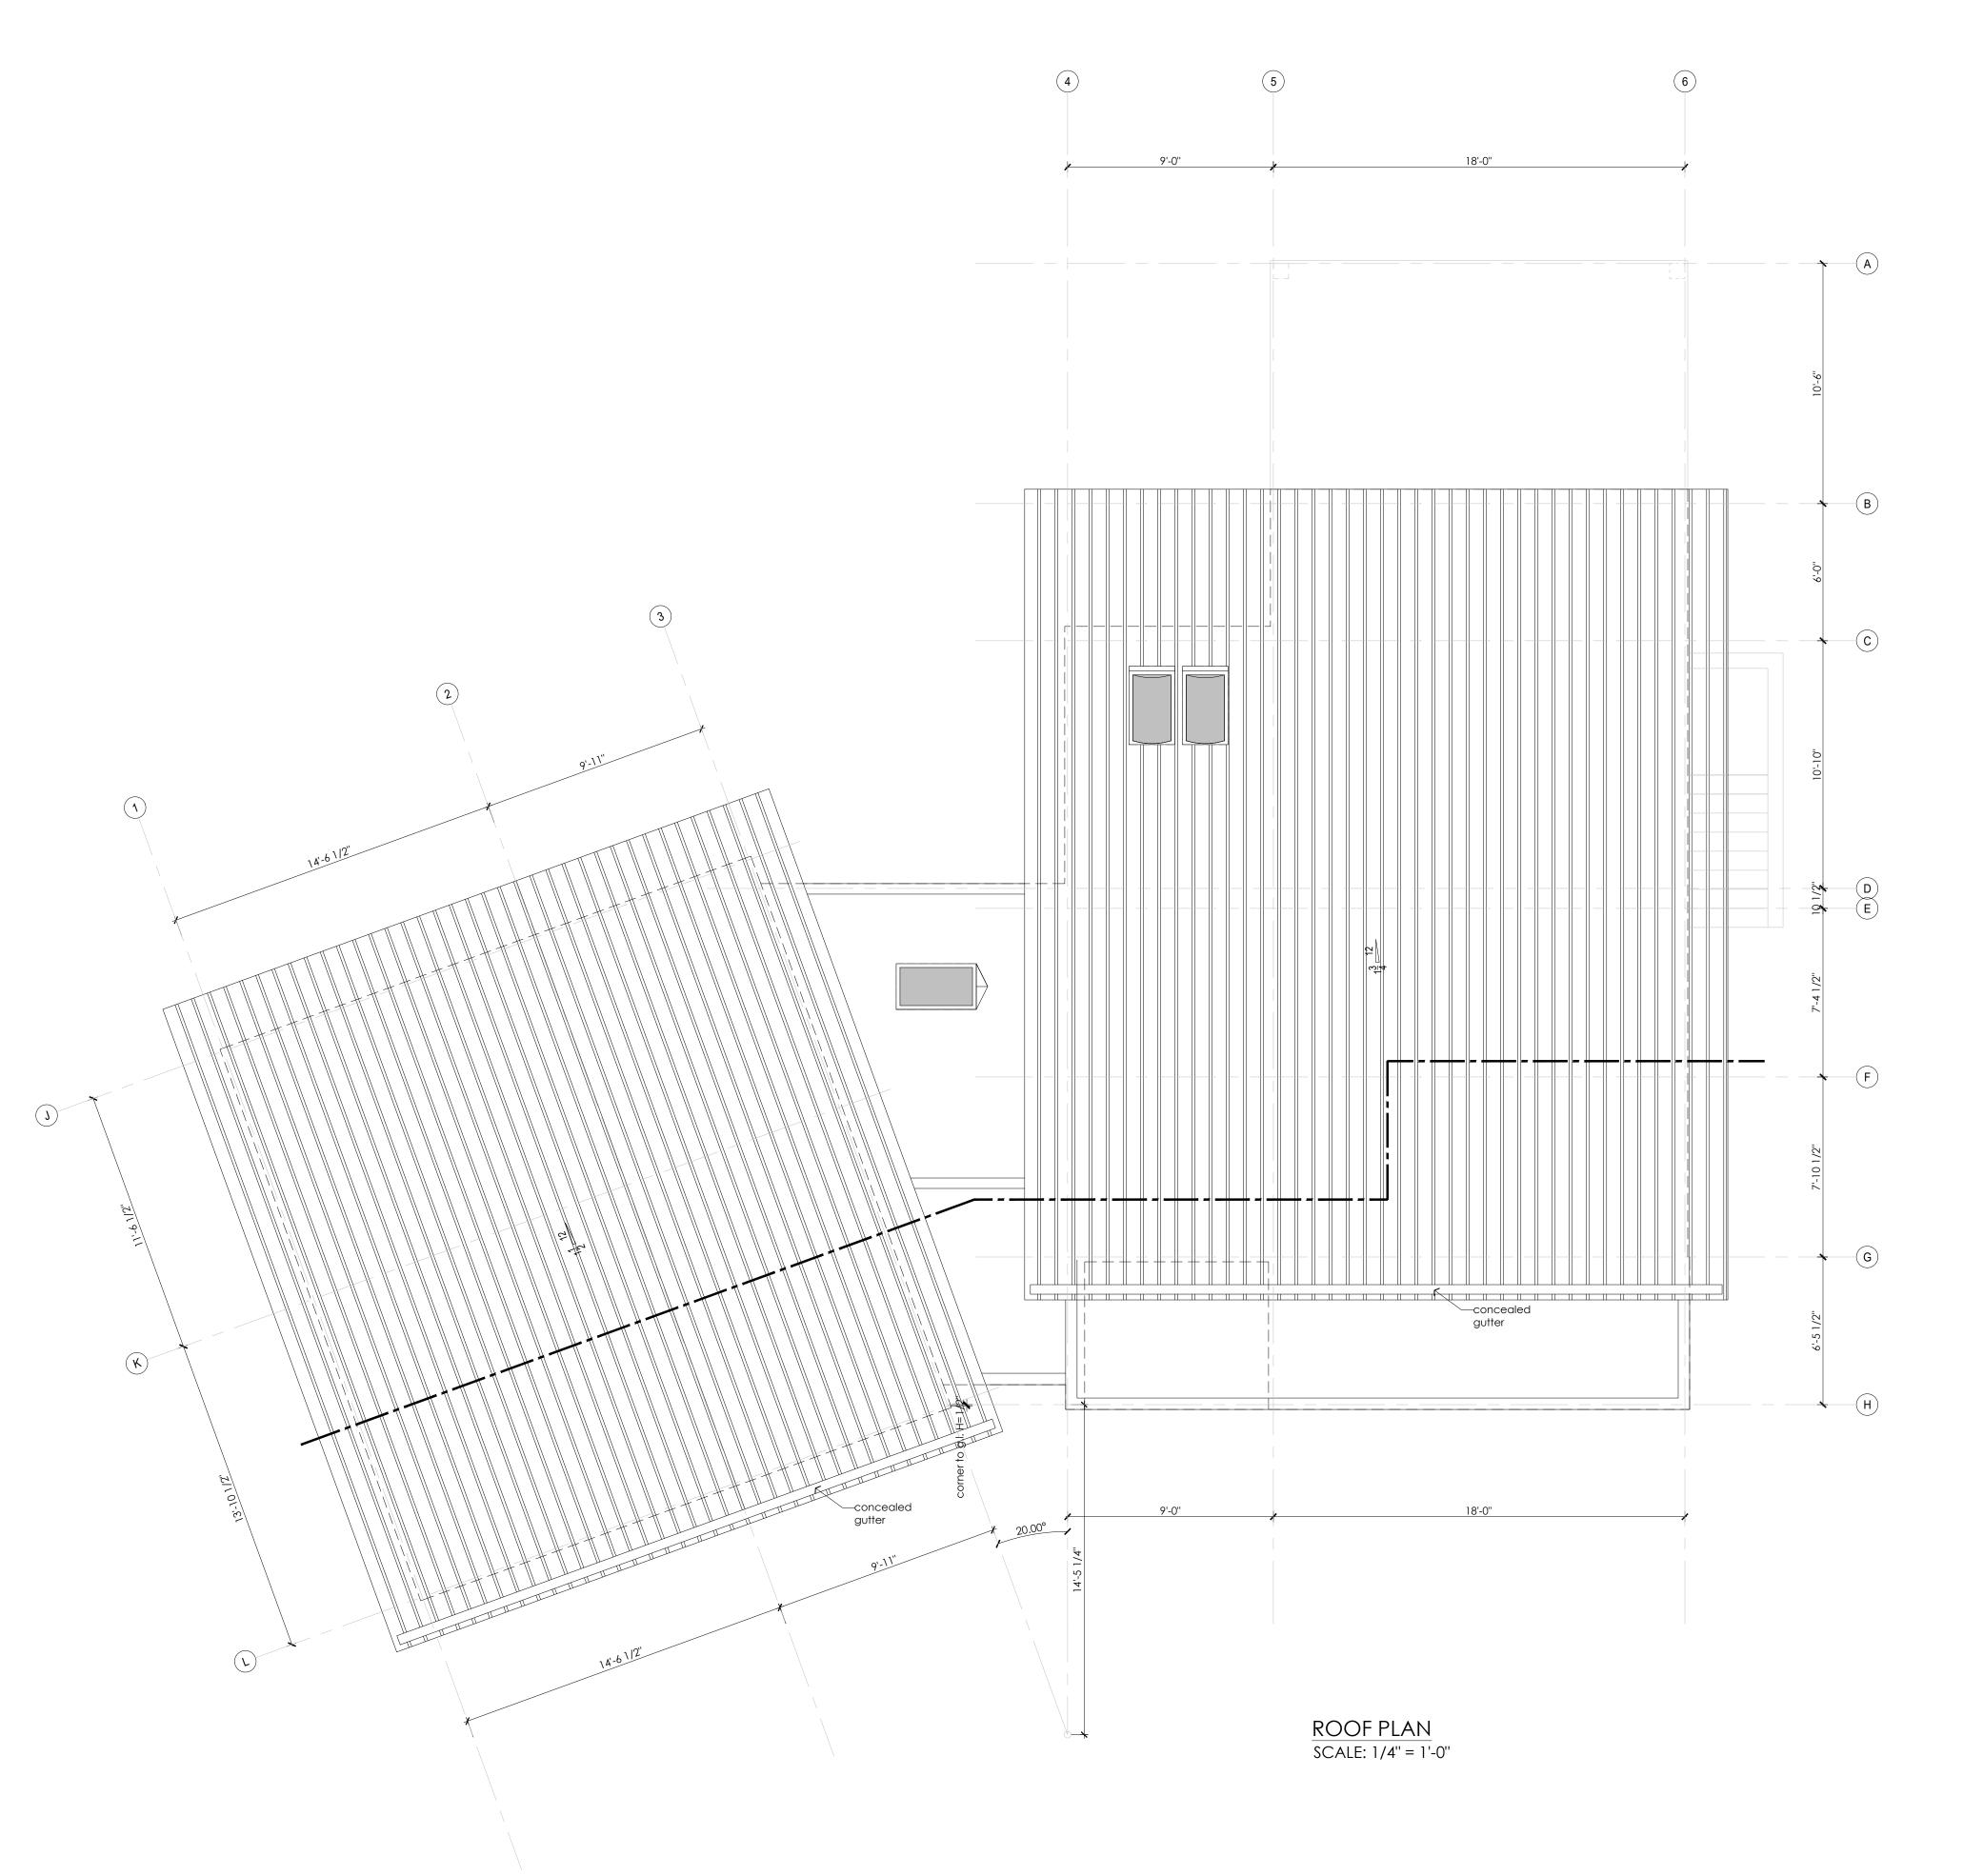



These designs and drawings are copyright Devise Design Inc. and cannot be used or copied, in full or in portion, without written or Verify all dimensions, datums and levels prior to construction. Report any discrepancies or omissions immediately. Do not scale this All work must comply with the most recent edition of the Chuilding a code and any other provening authorities.

PROJECT

SEGEV RESIDENCE

10230 - 81st STREET, OSOYOOS, BC

ISSUED

A Issued for DP/BP

10 JUN 21

REVISIONS

NOTES

DISCLAI

these drawings are intended for design reference only, and are not to be used as construction or permit drawings or for any purpose beyond their initial intent.

all information included in this drawing package is to be verified with the permitted construction drawings and confirmed with the owner.

devise design inc. waives any and all liability associated with the use of these drawings


DRAWING

Roof Plan

DRAWN BY: MM

CHECKED BY:

SCALE: 1/4"=

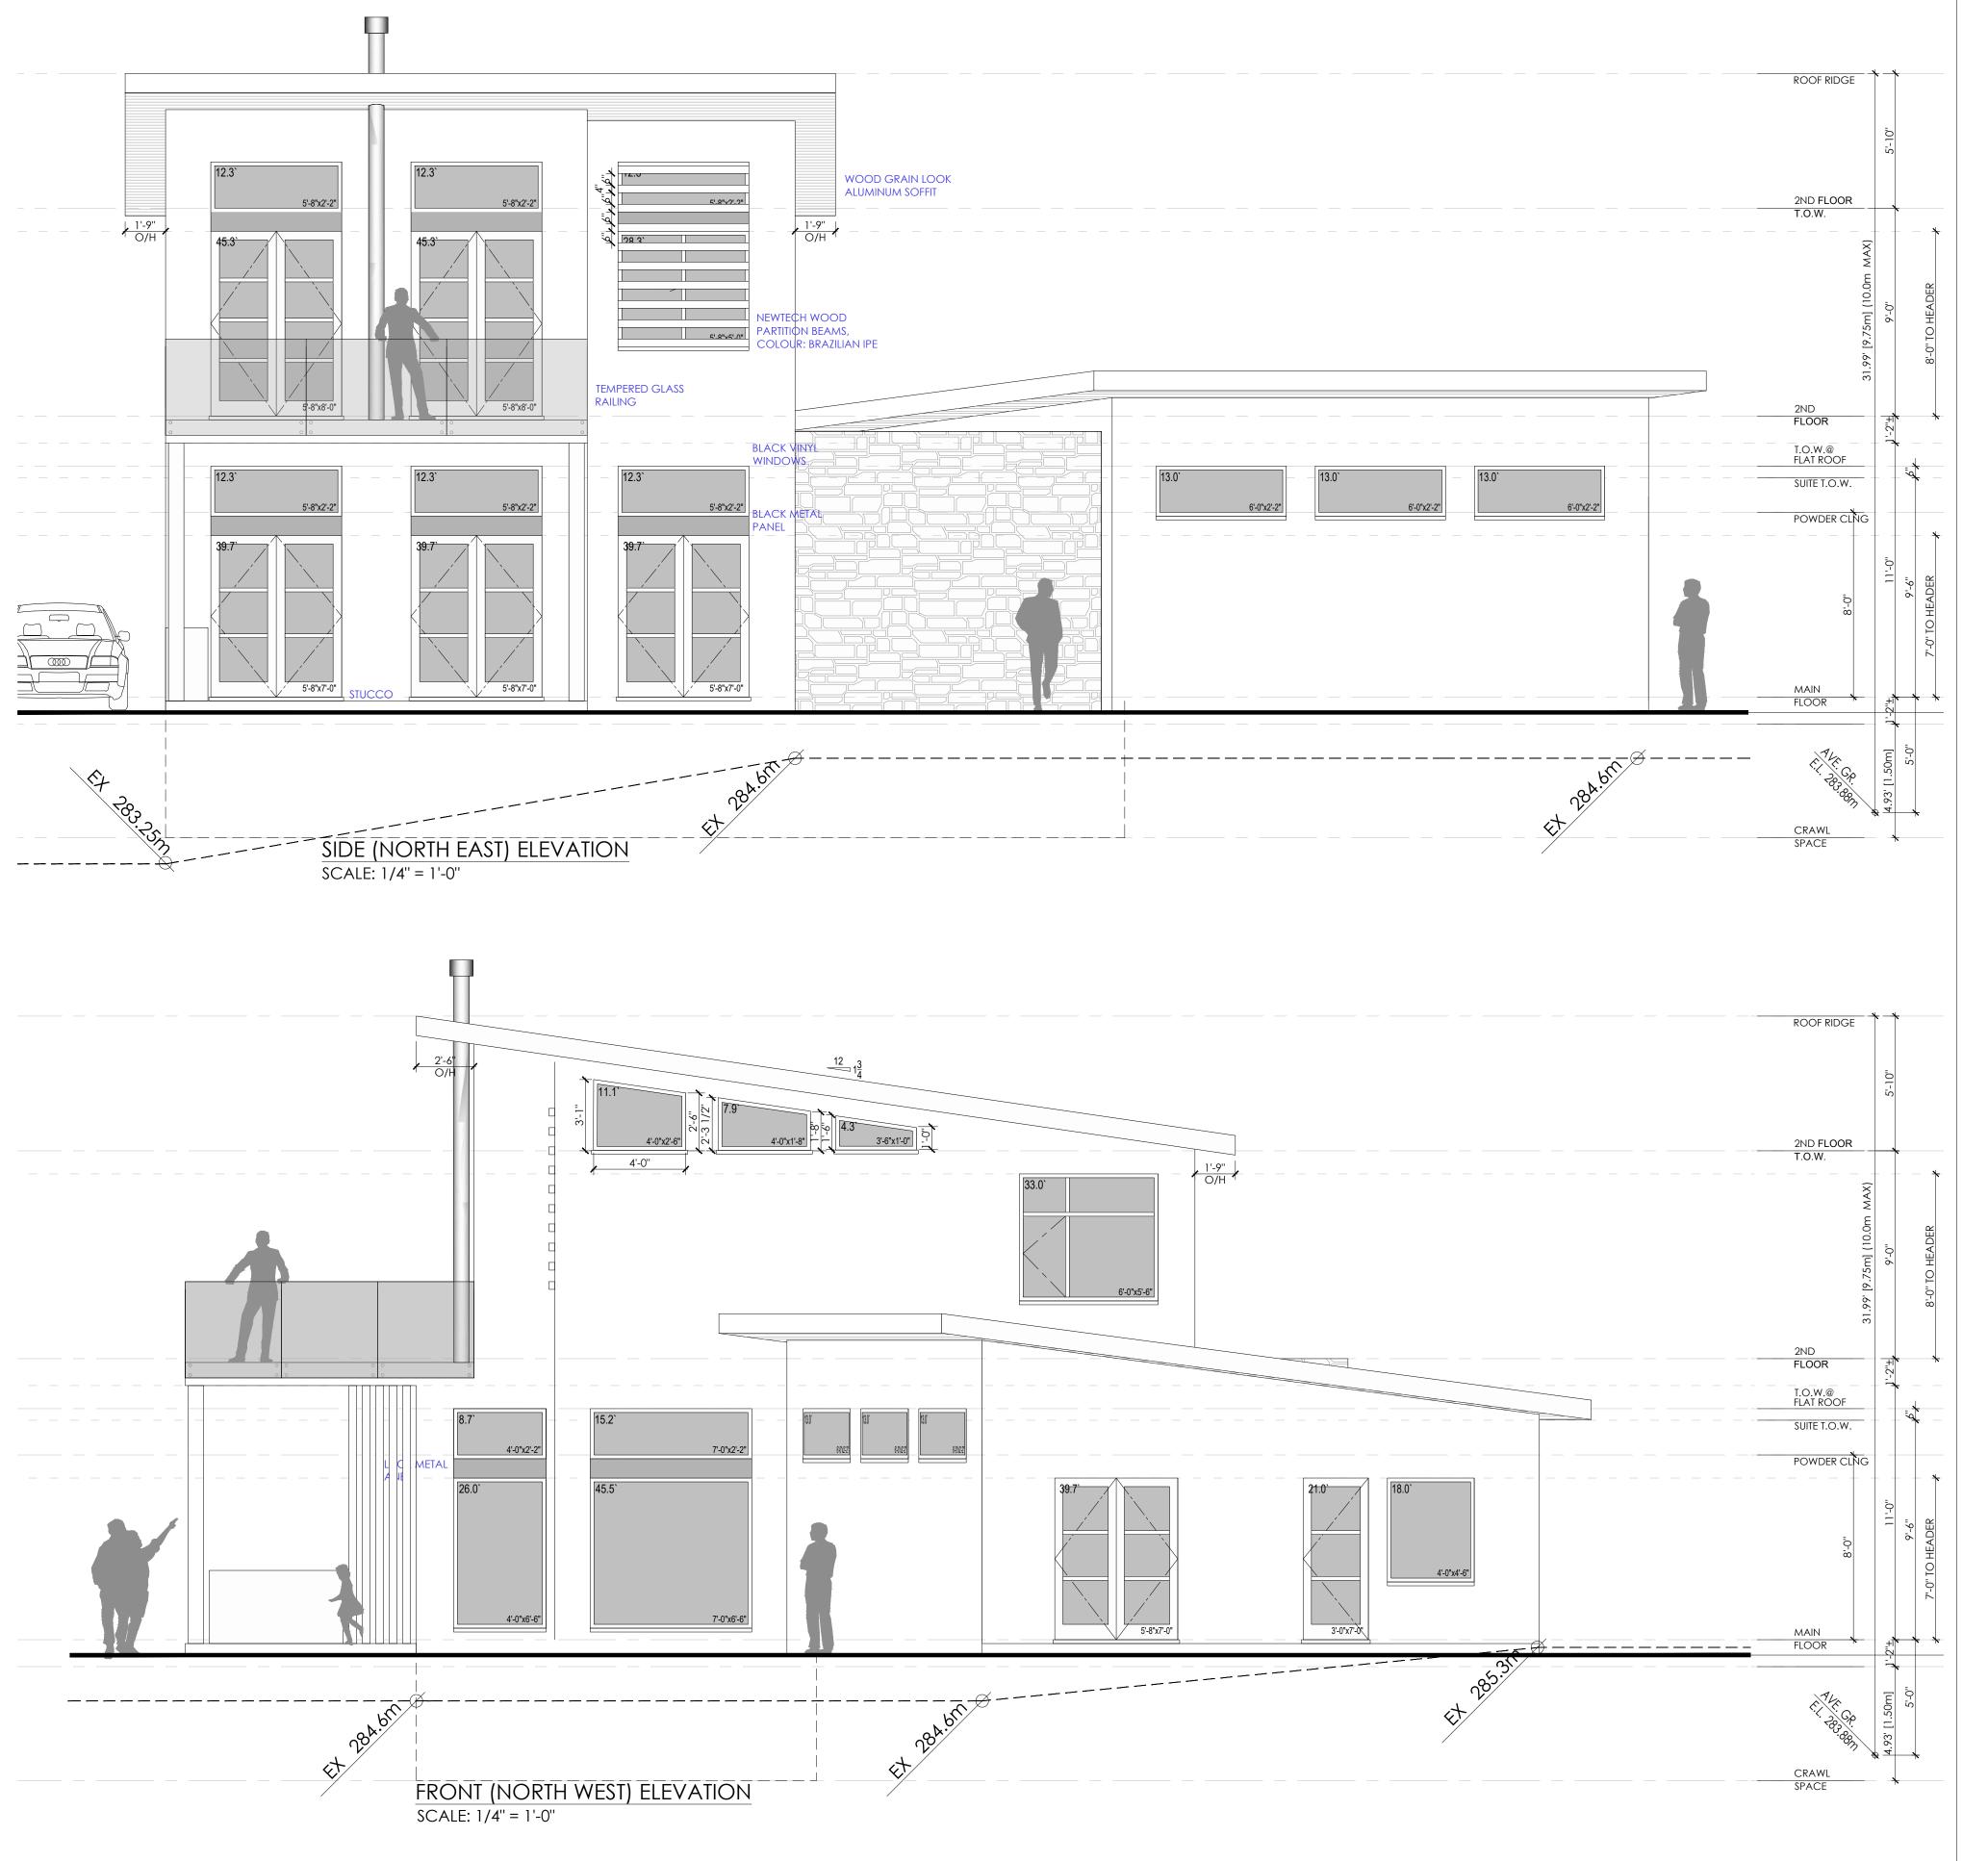

d e i s i g n

220, 275 E 1st Ave, Vancouver, BC, V5T 1A7 info@devisedesign.ca | 778.379.9636 www.devisedesign.ca

These designs and drawings are copyright Devise Design Inc. and cannot be used or copied, in full or in portion, without written const Verify all dimensions, datums and levels prior to construction. Report any discrepancies or omissions immediately. Do not scale this draw All work must comply with the most recent edition of the 8C building code and any other governing authorities.

PROJECT

SEGEV RESIDENCE

10230 - 81st STREET, OSOYOOS, BC

10 JUN 21

ISSUED

A Issued for DP/BP

REVISIONS

NOTES

DRAWING

North East & North West Elevations


AWN BY: MM S

CHECKED BY: KA

SCALE: 1/4"=1'0"

DATE: 01 MAY 21

A2.1

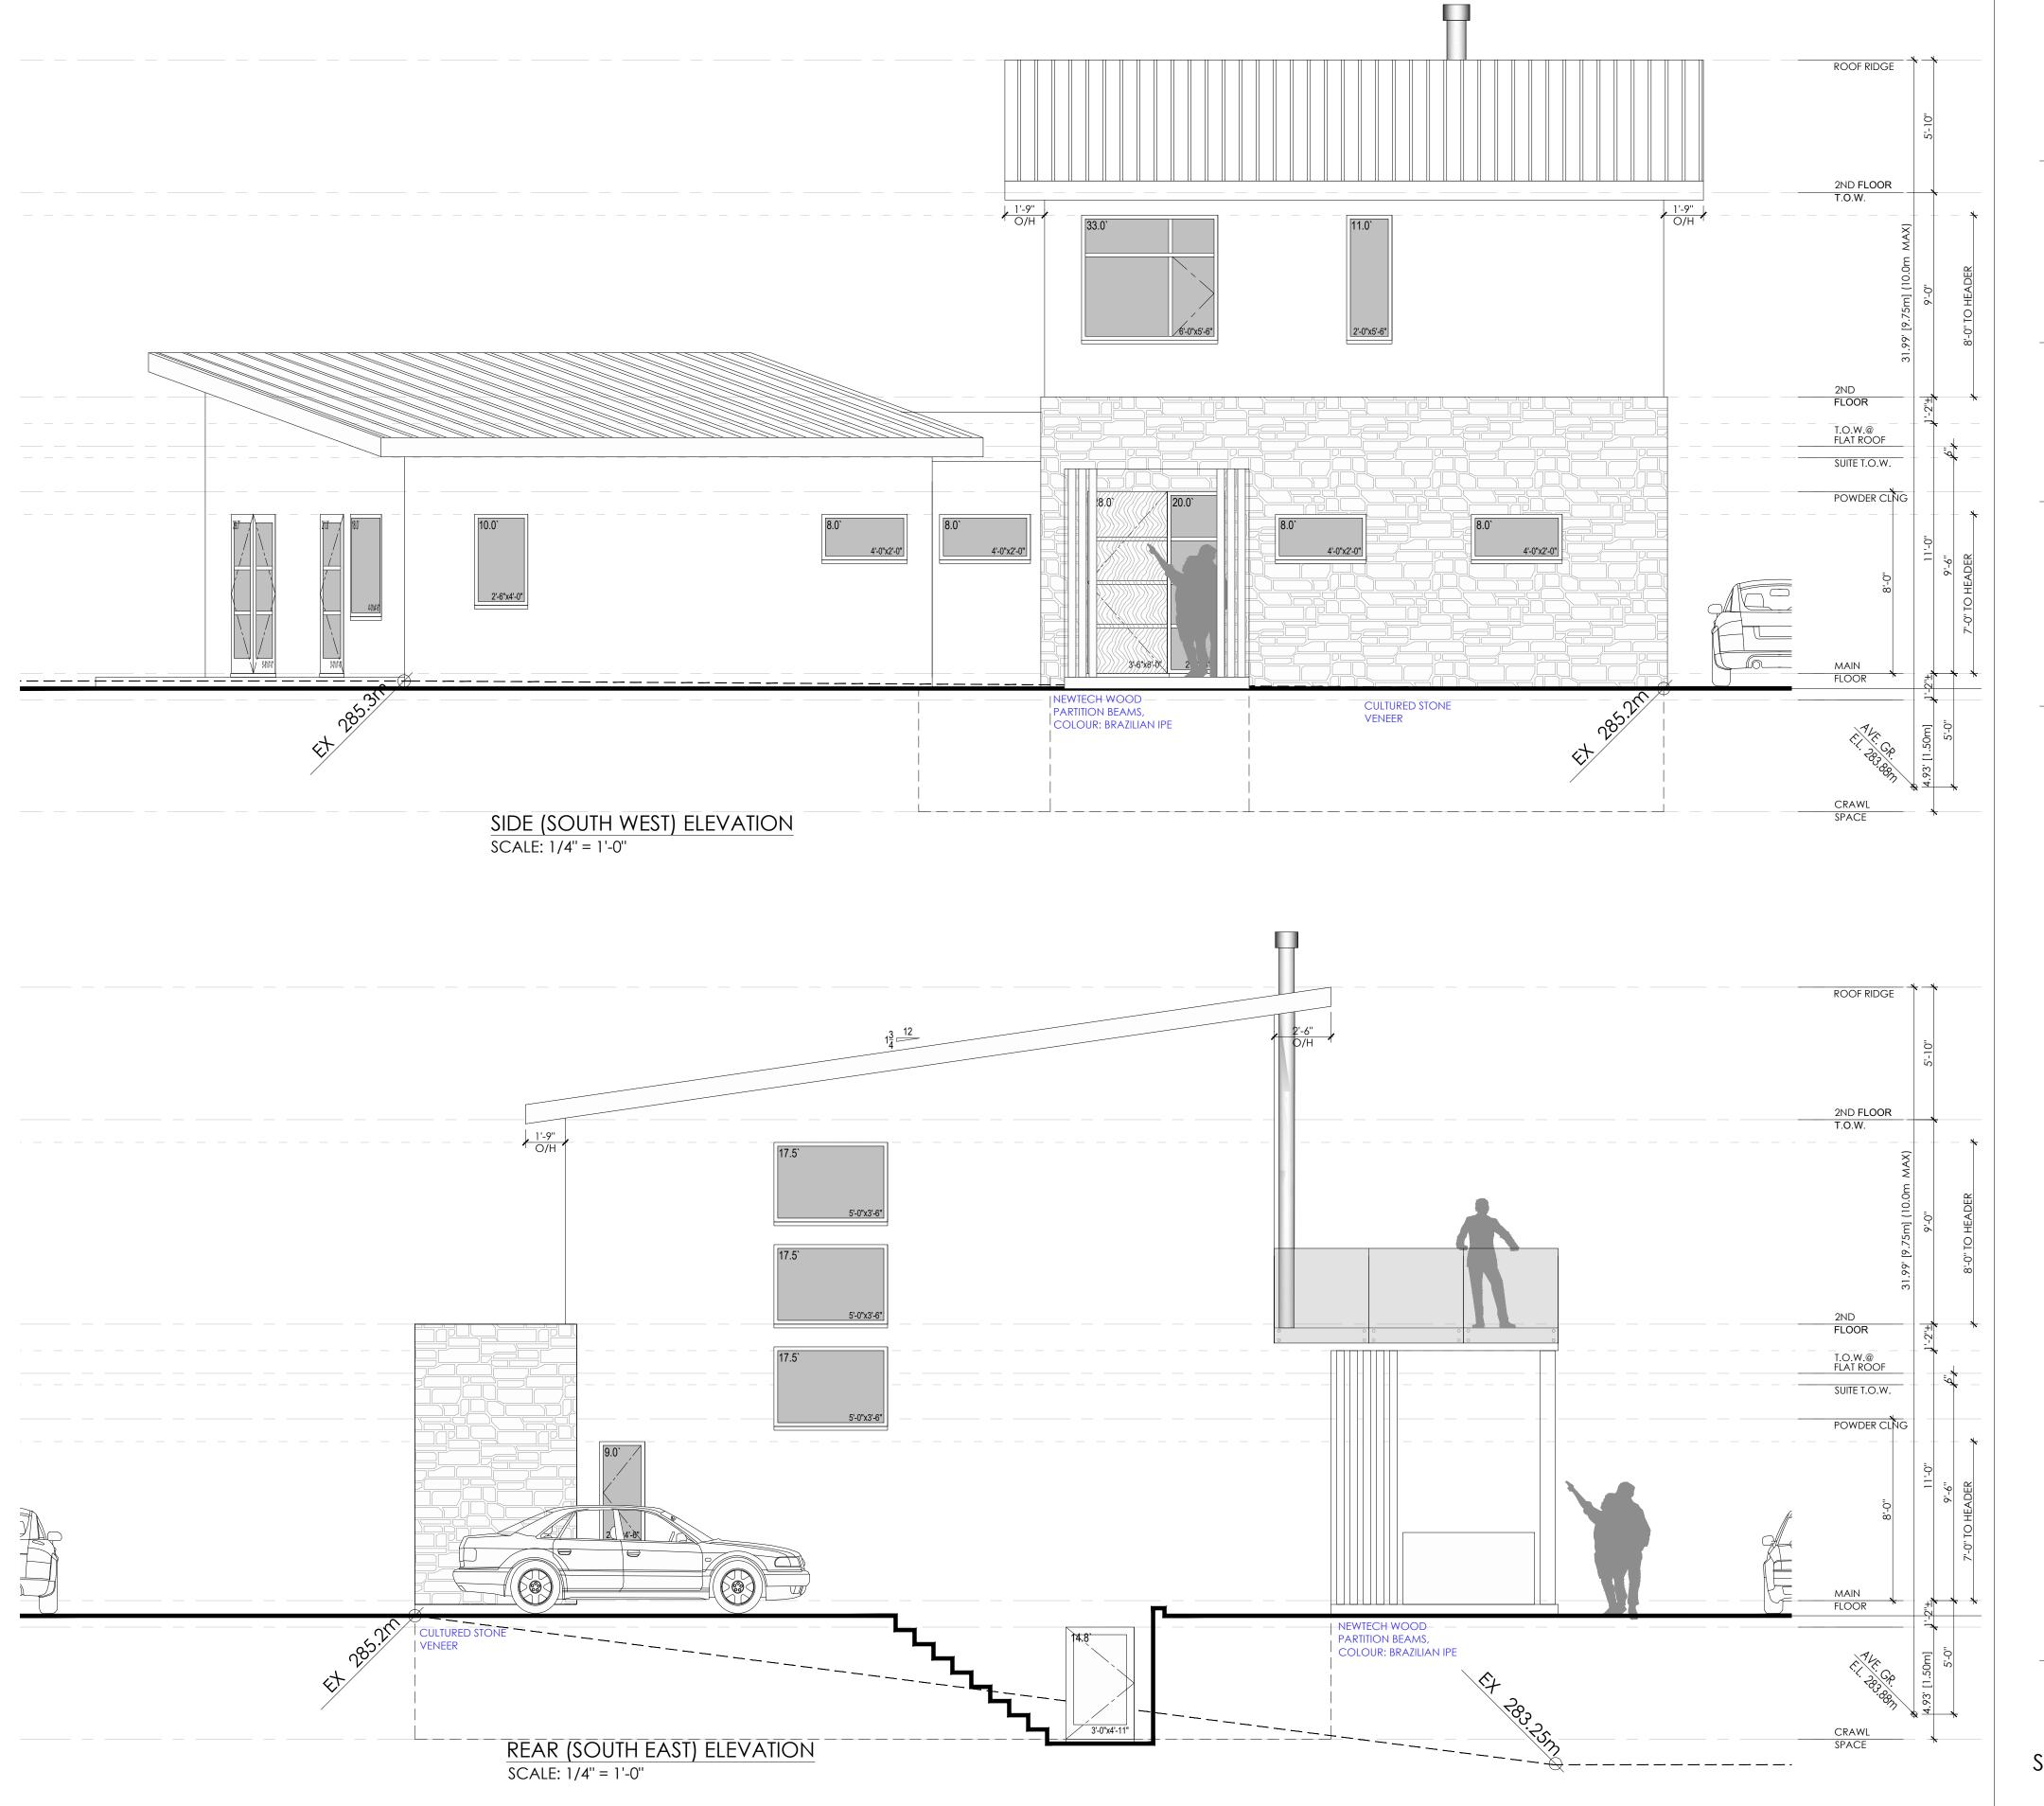



These designs and drawings are copyright Devise Design Inc. and cannot be used or copied, in full or in portion, without written or Verify all dimensions, datums and levels prior to construction. Report any discrepancies or omissions immediately, Do not scale this All work must comply with the most recent edition of the RE Challiding code and any other powering authorities.

PROJECT

SEGEV RESIDENCE

10230 - 81st STREET, OSOYOOS, BC

ISSUED

A Issued for DP/BP

10 JUN 21

REVISIONS

NOTES


DRAWING

South West & South East Elevations

RAWN BY: MM

CHECKED BY: K
SCALE: 1/4''=1

A2.2

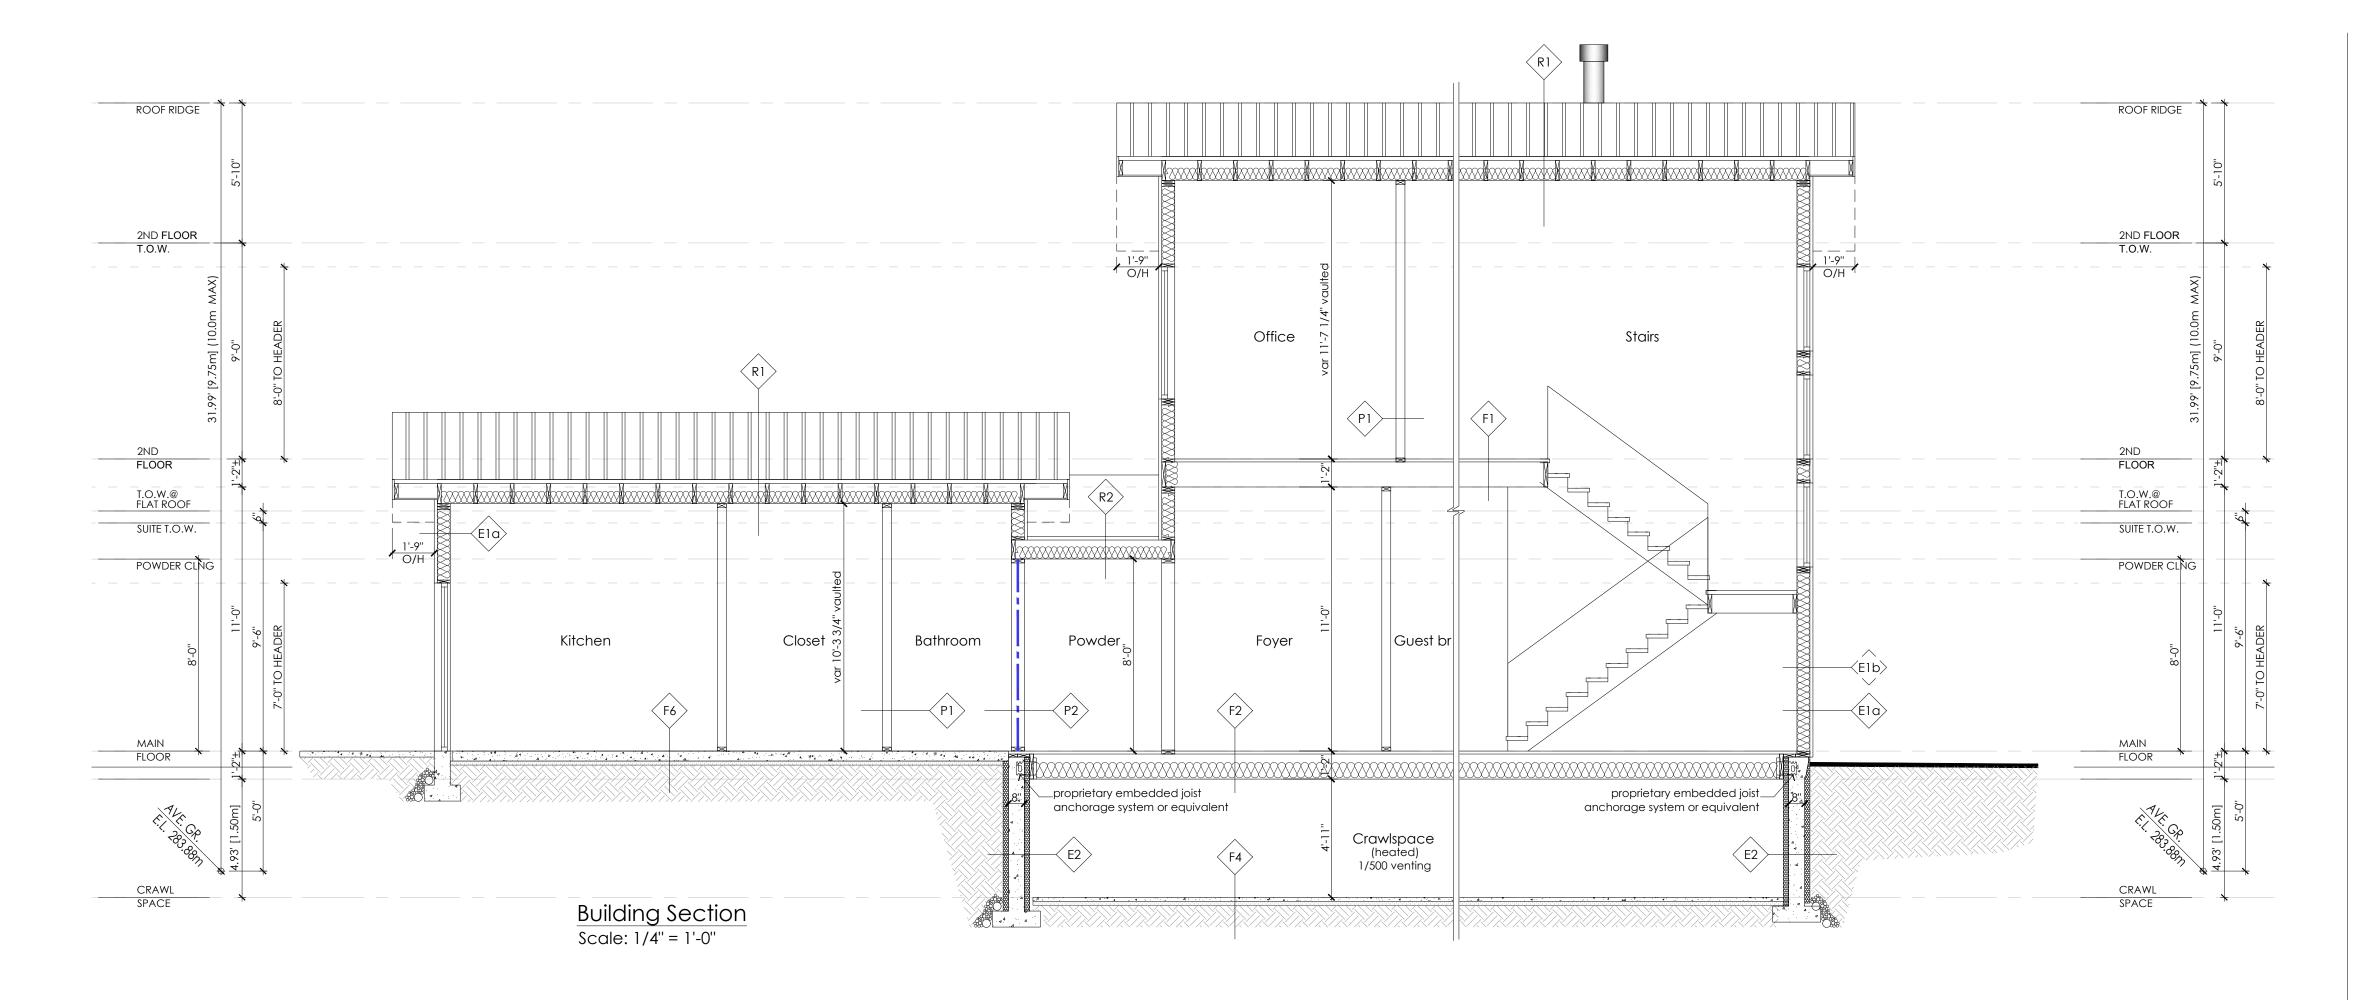

Assembly Schedule					
ID Tag	Туре	Assembly			
R1	Typ. Vaulted	Standing Seam Metal Roofing 15 lb. Felt Underlayment 5/8" Roof Sheathing 2-1/2" min gap/ Strapping (vent 1:150) 2x10 Rafters @ 12" & 16" o/c R31 HD Batt Insulation (Effective R24) 6 Mil Poly Vapour Barrier 1/2" Gypsum			
R2	Typ. Flat Roof	Torch-On Bituminous Membrane Waterproof membrane Plywood Subfloor 1-1/ 2" cross purlins w/ min. 2% slope to drain R-28 Batt insulation- effective R24 2x10 Floor joists (as per struct. eng.) 6 mil. Poly Vapour Barrier Waterproof Membrane 1/2" Gypsum (Vent 1:150)			

	Assembly Schedule					
ID Tag	Туре	Assembly				
	TJI Floor System	Finish Floor (As Specified)				
		3/4" Plywood Decking				
F1		11 7/8" Eng Wood Joists AS PER ENG.				
		1/2" Gypsum				
		(Vent 1:150)				
	TJI Floor over Crawlspace	Finish Floor (As Specified)				
		3/4" Plywood Decking				
F2		11 7/8" Eng Wood Joists as per eng.				
		R28 Batt Insulation				
		1/2" Gypsum				
		(Vent 1:150)				
	3 Found. Slab	Finish Floor (As Specified)				
		1 1/2" Conc. Top For Radiant Heat				
		4" CIP Concrete Slab (Reinforced As				
F3		Per Struct. Eng.)				
		6 mil Poly Vapour Barrier				
		3" Rigid XPS Insulation R15				
		6" Min. Compacted Granular Fill				

	Assembly Schedule				
ID Tag	Туре	Assembly			
	Deck over Living Space	Composite Decking			
		Torch-On Bituminous Membrane			
		Waterproof membrane			
		Plywood Subfloor			
		1-1/2" cross purlins w/ min. 2% slope to			
		drain (Vent 1:150)			
F4		2x10 Floor joists (as per struct. eng.)			
		R-32 Batt insulation			
		6 mil. Poly Vapour Barrier			
		Waterproof Membrane			
		Aluminum Soffit			
	Deck	Composite Decking			
		Torch-On Bituminous Membrane			
		Waterproof membrane			
F5		Plywood Subfloor			
		2x10 Floor joists (as per struct. eng.)			
		Aluminum Soffit			
	Crawlspace Slab	2"Conc. skim coat			
F6		Vapour Retarder			
10		R12 Rigid Insulation			
		Compact fill or Sand solid bearing			

Wall Schedule		
ID Tag	Туре	Assembly
Ela	Ext. Wall	Ext. Finish (3/4")- Stucco 3/4" Rain Screen Building Paper 1/2" Plywood sheathing 2X6 Wood Studs @ 16" O.C. min. R22 Insulation 6 mil Poly. Vapour Barrier 1/2" Gypsum
Elb	Ext. Wall	Stone Cladding 1/2" Scratch Coat Delta-Dry & Lath- 10mm rainscreen & fiberglass lath Delta Vent SA, Peel & Stick Housewrap or similar 1/2" Plywood sheathing 2X6 Wood Studs @ 16" O.C. min. R22 Insulation 6 mil Poly. Vapour Barrier 1/2" Gypsum
E2	Found. Wall	Drainage Mat Bituminous Damp-Proof Memb. 2 5/8" ICF Rigid Panel 8" Concrete Foundation Wall 2 5/8" ICF Rigid Panel
ΡΊ	2x4 Partition	1/2" Gypsum 2x4 Framing @ 24" o/c 1/2" Gypsum
P2	1 hr F.R.R. Interior Wall BCBC W3A STC 45	5/8" Type "X" Gypsum Board 2x4 Studs @ 16" o/c Absorbtive material in cavity Resilient Channel @ 16"/24" o/c



These designs and drawings are copyright Devise Design Inc. and cannot be used or copied, in full or in portion, without written or Verify all dimensions, datums and levels prior to construction. Report any discrepancies or omissions immediately. Do not scale this d All work must comply with the most recent edition of the BC building code and any other governing authorities.

PROJECT

SEGEV RESIDENCE

10230 - 81st STREET, OSOYOOS, BC

ISSUED

A Issued for DP/BP

10 JUN 21

REVISIONS

NOTES

DRAWING

Building Section

RAWN BY: MM

SCALE: 1/4"=

A3.1