
PARTITION SCHEDULE						
TAG	TYPE	RATING	CONSTRUCTION			
P1	EXTERIOR BRICK WALL	1 HR	• BRICK EXTERIOR • 2x6" STEEL STUDS @ 16" O/C • NEW R24 BATT INSULATION • NEW 6 MIL POLY VAPOUR BARRIER • NEW %" TYPE 'X' GYPSUM BOARD			
P2	EXTERIOR CONCRETE BLOCK WALL	1 HR	• EXISTING PLASTER FINISH • EXISTING CONCRETE BLOCK • NEW 2x4" STEEL STUDS @ 16" O/C • NEW %" TYPE 'X' GYPSUM BOARD			
Р3	FIRE RATED INTERIOR PARTY WALL	1 HR	•5/8" TYPE 'X' GYPSUM BOARD •2x6" STEEL STUDS @ 16" O/C •5 1/2" SOUND ATTENUATION (REF. PRODUCT JOHNS MANVILLE) •5/8" TYPE 'X' GYPSUM BOARD			
P4	INTERIOR PARTITION	_	• 1/2" TYPE 'X' GYPSUM BOARD • 2x4" STEEL STUDS @ 16" O/C • 3 1/2" SOUND ATTENUATION (REF. PRODUCT JOHNS MANVILLE) • 1/2" TYPE 'X' GYPSUM BOARD			

TAG	TYPE	WIDTH	HEIGHT	NOTES		
D1	EXTERIOR GLAZED FRONT ENTRANCE	36"	80"	KEYED LOCK		
D2	INTERIOR	32"	80"	NON LOCKING HANDLE		
D3	SUITE CONNECTING	36"	80"	INTERCONNECTING HARDWAF AND KEYED DEADBOLT		
D4	POCKET	32"	80"			
D5	EXTERIOR OPAQUE	36"	80"	KEYED LOCK		
D6	INTERIOR CLOSET DOOR	24"	80"	NON-OPERABLE HANDLE AND TOP BUTTON HARDWA		
D7	INTERIOR CLOSET DOOR	36"	80"	NON-OPERABLE HANDLE AND TOP BUTTON HARDWA		

WINDOW SCHEDULE					
TAG	TYPE	QTY	WIDTH	HEIGHT	NOTES
W1	VINYL FIXED/SLIDING WINDOW	6	6'-0"	6'-0"	
W2	BEDROOM SLIDING WINDOW	1	3'-0"	5'-0"	
W3	HIGH SLIDING WINDOW WITH EGRESS	3	6'-0"	2'-3½"	
W3	HIGH SLIDING WINDOW	2	6'-0"	1'-7"	

W3	HIGH SLIDING WINDOW	2	6'-0"	1'-7"				
NOTES: 1. ENERGY EFFICIENCY USI 1.4 OR LESS								


ALL WINDOWS TO BE VINYL WITH DOUBLE GLAZED SEALED UNITS (RESIDENTIAL) DIMENSIONS ARE SHOWN TO WINDOW FRAMES. CONTRACTOR TO CONFIRM ROUGH OPENING SIZES WITH WINDOW MANUFACTURER AND CONFIRM EXISTING OPENINGS 4. ALL EXTERIOR WINDOWS TO CONFORM TO NAFS 30 OR BETTER.

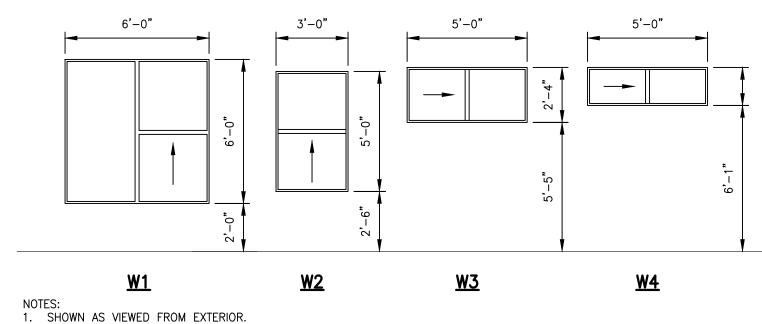



KEY NOTES: STACKABLE WASHER AND DRYER
 ROTATING PRIVACY WALL. 3. 6'-0" PONY WALL. **GENERAL NOTES:**

1. EXISTING CEILING HEIGHT IS APPROX. 12'-0" FROM TOP OF CONCRETE FLOOR TO UNDERSIDE OF CONCRETE CEILING. 2. CONTRACTOR TO VERIFY DIMENSIONS ON SITE PRIOR TO ORDERING MATERIALS. FRAME DRYWALL CEILING AT 10'-0" A.F.F. PROVIDE ACCESS PANELS FOR ANY PLUMBING CLEANOUTS OR VALVES IN CEILING SPACE. 4. REMOVE EXISTING DOOR AND MAKE GOOD BRICK

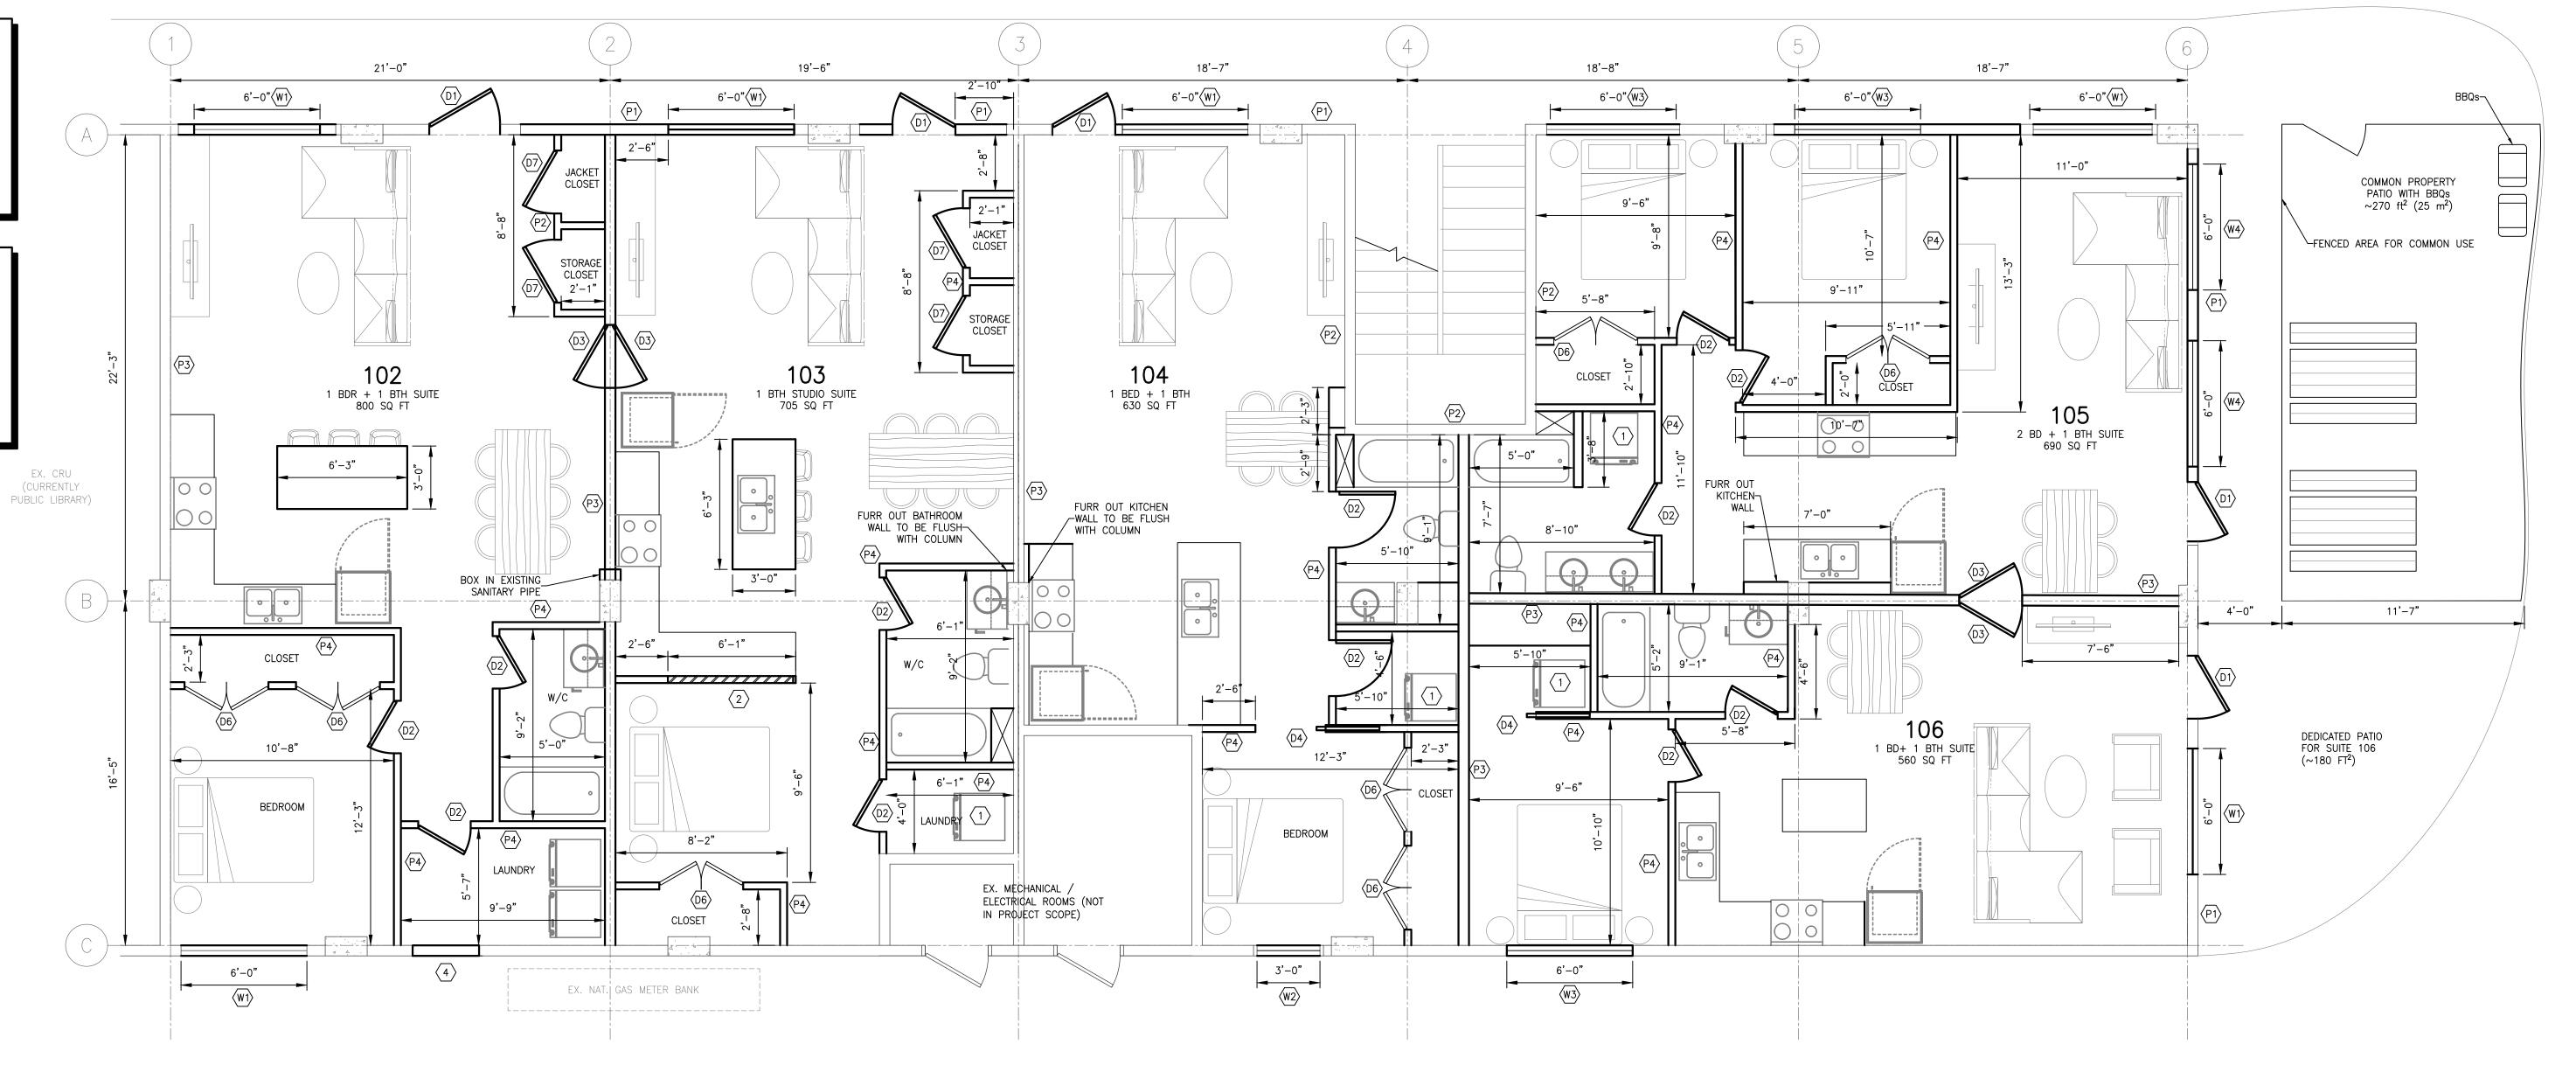

PROPOSED LAYOUT SCALE: 1/4" = 1'-0"

DRAFTING

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KONONOFF

HISTORY

A OCT 14, 2020 ISSUED FOR INITIAL REVIEW B OCT 23, 2020 ISSUED FOR REVIEW C DEC 3, 2020

ISSUED FOR PRICING D JAN 5, 2021 E JAN 21, 2021 REVISED FOR PRICING F JAN 27, 2021 REVISED WINDOW SHEDULE

ISSUED FOR DEVELOPMENT PERMIT

PROJECT TITLE PROJECT ADDRESS

DRAWING TITLE

OK FALLS CONDOS MAIN FLOOR CONVERSION 850 RAILWAY LANE, OK FALLS, BC V0H 1R4

MAIN FLOOR PLAN PROPOSED LAYOUT DRAWING NO. **REVISION F**